EXISTING WATER PIPE TO BE REMOVED/ABANDONED IN PLACE AIR RELEASE VALVE

WATER SAMPLING STATION

STREET LIGHT CONDUIT, WIRING & PULL BOX

DIRECTION OF SURFACE DRAINAGE FLOW

STREET CENTERLINE OR BASELINE

TREE TO BE REMOVED

EXISTING GROUND SURFACE ELEVATION

0

DETAIL NO. / SHEET NO.

SURVEY CONTROL POINT POTHOLE LOCATION

HB

EC


0

CONCRETE PATH [RR] HB HOSE BIB EC ELECTRICAL VAULT GAS METER


IMPROVEMENT PLANS FOR NORTH DAVIS MEADOWS WATER SYSTEM CONSOLIDATION PROJECT

NORTH DAVIS MEADOWS COUNTY SERVICE AREA

YOLO COUNTY, CALIFORNIA

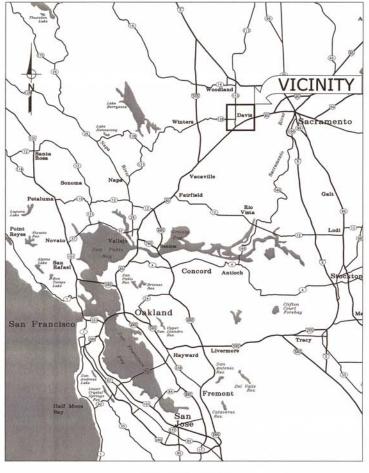

VICINITY MAP NOT TO SCALE

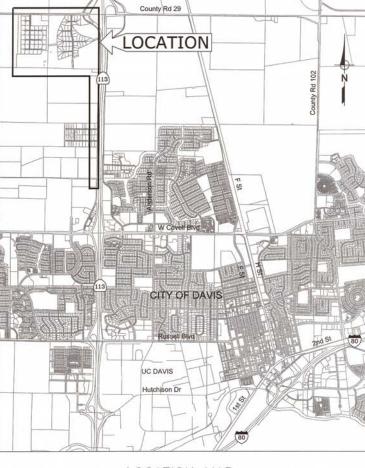

LOCATION MAP NOT TO SCALE

	AGENCY/UT	TLITY CONTACTS				
UTII	LITY	REPRESENTATIVE				
GAS	PG&E	BRENT DRAWVER	(661)637-9807			
ELECTRICITY	PG&E	BRENT DRAWVER	(661)637-9807			
PHONE	AT&T	CHARLENE SASAMOTO	(707)258-5308			
CABLE	COMCAST	MARK DUBY	(916)830-6743			
WATER/SEWER	CITY OF DAVIS	STAN GRYCZKO	(530)747-8292			

DESIGNED_AJU DRAWN___JRR CHECKED_KLW_ NO. BY DATE REVISION APP'D DATE

COUNTY OF YOLO DEPARTMENT OF COMMUNITY SERVICES APPROVED FOR CONSTRUCTION

DATE 12/6/2018 TARO ECHIBURU COMMUNITY SERVICES DIRECTOR

APPROVED FOR EXTENSION OF CITY OF DAVIS WATER SYSTEM CITY ENGINEER DATE APPROVED 12- %- 2018

CITY OF DAVIS

DESIGN ENGINEER

BY ASA J. UTTERBACK ENGINEER'S NAME DATE JANUARY 12, 2018 P.E. C57700 REGISTRATION EXPIRES 12/31/2019



2020 Research Park Drive Suite 100 Davis, California 95618

1	G01	IIILE SHEET
2	G02	GENERAL NOTES
3	G03	ALIGNMENT CONTROL AND STAGING AREA PLAN
4	G04	SURVEY CONTROL PLAN AND POTHOLE DATA
	.1102.52.00	DETAILS
5	D01	TYPICAL SECTIONS AND STANDARDS 1
6	D02	TYPICAL SECTIONS
7	D03	WATER SERVICE DETAILS
8	D04	DETAILS 1
9	D05	DETAILS 2
10	D06	DETAILS 3
11	D07	DETAILS 4
		CIVIL
12	C01	GRANITE BAY PL - COVEY CT - NORTH STAR PL PLAN AND PROFILE
13	C02	BLACKHAWK PL PLAN AND PROFILE
14	C03	SPYGLASS PL PLAN AND PROFILE
15	C04	SPANISH BAY PL PLAN AND PROFILE
16	C05	SILVERADO DR PLAN AND PROFILE 1
17	C06	SILVERADO DR PLAN AND PROFILE 2
18	C07	LARKSPUR PL PLAN AND PROFILE
19	C08	LUPINE COURT PLAN AND PROFILE
20	C09	MORNING DOVE PL PLAN AND PROFILE
21	C10	PRIMROSE PL PLAN AND PROFILE
22	C11	FAIRWAY DR PLAN AND PROFILE 1
23	C12	FAIRWAY DR PLAN AND PROFILE 2
24	C13	FAIRWAY DR PLAN AND PROFILE 3
25	C14	GOLF COURSE FAIRWAY NORTH PLAN AND PROFILE
26	C15	GOLF COURSE FAIRWAY SOUTH A PLAN AND PROFILE 1
27	C16	GOLF COURSE FAIRWAY SOUTH A PLAN AND PROFILE 2
28	C17	GOLF COURSE FAIRWAY SOUTH A PLAN AND PROFILE 3
29	C18	GOLF COURSE FAIRWAY SOUTH B PLAN AND PROFILE 1
30	C19	GOLF COURSE FAIRWAY SOUTH B PLAN AND PROFILE 2
31	C20	COUNTY ROAD 99D PLAN AND PROFILE 1
32	C21	COUNTY ROAD 99D PLAN AND PROFILE 2
33	C22	COUNTY ROAD 99D PLAN AND PROFILE 3
34	C23	COUNTY ROAD 99D PLAN AND PROFILE 4
35 36	C24 C25	COUNTY ROAD 99D PLAN AND PROFILE 5 COUNTY ROAD 99D PLAN AND PROFILE 6
		ADDROLLAND COMPANY AND

SHEET INDEX

GENERAL

SHEET TITLE

SHEET DWG

NO. NO.

GO1 TITLE SHEET

BID DOCUMENTS

COUNTY OF YOLO DEPARTMENT OF COMMUNITY SERVICES IMPROVEMENT PLANS FOR NORTH DAVIS MEADOWS WATER SYSTEM CONSOLIDATION PROJECT

AS SHOWN DATE: 12/06/2018

SCALE

TITLE SHEET

G01 SHEET NO 1 of 36

DWG NO

12/5/2018

601

Clients\

DESIGNED_AJU

AGGREGATE BASE MFR MANUFACTURE ASPHALT CONCRETE ABOVE FINISH FLOOR MAX MAXIMUM ALLIMINI IM AIR RELIEF VALVE MECHANICAL JOINT MON MONUMENT MONITORING MOTOR OPERATED VALVE NEW, NORTH BLIND FLANGE BLOW-OFF VALVE NOT IN CONTRACT NUMBER NOT TO SCALE COMBINATION AIR/VACUUM ON CENTER OUTSIDE DIAMETER OVERFLOW CENTER LINE OVERHEAD PLATE, PROPERTY LINE PRESSURE RELIEF VALVE CONTROL LOW STRENGTH CLEAN OUT POINT OF REVERSE CURVE CONCRETE PRESSURE REDUCING CONCRETE MASONRY UNIT POUNDS PER SQUARE PSF CHECK VALVE DRAIN INLET POUNDS PER SQUARE PSI PRESSURE GAUGE DUCTILE IRON PIPE DRAWING PUBLIC UTILITY EASEMENT PLUG VALVE POLYVINYL CHLORIDE PIPE END HORIZONTAL CURVE EACH FACE PVM'T PAVEMENT FI EVATION RADIUS REINFORCED CONC PIPE EDGE OF PAVEMENT REQUIRED FOLIPMENT REVISION END VERTICAL CURVE EACH WAY RESTRAINED JOINT RAII ROAD FXISTING R/W SEWER, SOUTH, SLOPE FINISHED FLOOR SCHEDULE. FIRE HYDRANT STORM DRAIN MANHOLE FLANGED COUPLING SUMP PUMP DISCHARGE SQUARE FLOOR CLEANOUT SANITARY SEWER FLOOR DRAIN SSMH SST SANITARY SEWER MANHOLE FLANGE STAINLESS STEEL FIBER OPTIC FIBERGLASS REINFORCED STD STANDARD FACE OF CURB SIDEWALK GAI VANIZED TELEPHONE TOP & BOTTOM
TOP OF CONCRETE
TOP OF STEEL OR TOP GRADE BREAK T&B TOC TOS GROUND SURFACE GROUND SURFACE GSP PROFILE OF STRUCTURAL FRAME TYP UNDERGROUND HOT MIX ASPHALT UNION PACIFIC RAILROAD HIGH POINT IN PVMT, HIGH PRESSURE VARIOUS VERTICAL POINT OF INTERSECTION VENT THROUGH ROOF HORIZONTAL POINT OF VTR INFLECTION HOR7 INVERT ELEVATION WATER SURFACE WELDED WIRE FABRIC RIGATION LATERAL

CONSTRUCTION IN GOLF COURSE

- 1. NOTIFY THE GOLF COURSE MANAGER, JERRY LILLIEDOLL, AT THE DAVIS MUNICIPAL NOTIFY THE GOLF COURSE MANAGER, JERRY LILLEDULL, AT THE DAYS BEFORE GOLF COURSE (756-4010 OR 756-0647) A MINIMUM OF THREE DAYS BEFORE STARTING CONSTRUCTION OF THE WATER MAIN ON THE GOLF COURSE. COORDINATE WITH JERRY THE SCHEDULE OF CONSTRUCTION OF THAT HE CAN SET UP TEMPORARY GREENS AND TEES, OR CAN CLOSE GOLF HOLES AS NEEDED. WATER MAIN CONSTRUCTION ACROSS THE GOLF COURSE IS TO BE DONE AS QUICKLY AS POSSIBLE.
- 2. ANY IRRIGATION LINES THAT NEED TO BE CUT FOR CONSTRUCTION OF THE WATER MAIN ARE TO BE REPAIRED AND IN WORKING CONDITION BY 6PM DAILY TO ALLOW
- 3. ALL EXISTING LAWN AND/OR LANDSCAPING THAT IS DAMAGED OR REMOVED BY CONTRACTOR'S OPERATIONS SHALL BE REPLACED IN-KIND TO THE SATISFACTION OF THE GOLF COURSE MANAGER AT NO ADDITIONAL EXPENSE TO COUNTY.
- 4. FOR ALL WORK OUTSIDE OF EXISTING ROAD RIGHT-OF-WAY, CONTRACTOR SHALL KEEP ALL WORK, MATERIALS AND EQUIPMENT WITHIN A FORTY FOOT (40') WIDE STRIP OF LAND CENTERED ON THE PIPE ALIGNMENT, UNLESS OTHERWISE APPROVED BY GOLF COURSE MANAGER. CONSTRUCTION VEHICLES AND MATERIALS SHALL BE PLACED ON THE SIDES OF THE FAIRWAY AS DIRECTED BY GOLF COURSE MANAGER.

WATER GENERAL NOTES

- 1. WHERE VALVE INSTALLATION IS SHOWN ADJACENT TO A TEE, BEND OR CROSS, ATTACH
- 2. POSITIONS OF EXISTING WATER MAIN ARE SHOWN BASED ON CITY SYSTEM MAPPING AND AVAILABLE VALVE LOCATIONS. FIELD VERIFY LOCATIONS BEFORE BEGINNING
- 3. PRIOR TO BEGINNING ANY WORK INVOLVING WATER SYSTEM SHUTDOWN, PREPARE AND SUBMIT WATER SYSTEM SHUTDOWN PLAN SCHEDULING ALL WORK SHOWN ON THESE WATER SYSTEM PLANS TO LIMIT THE NUMBER AND DURATION OF ALL PLANNED SHUTDOWNS OF THE WATER SERVICE TO EXISTING CONNECTED USES IN ACCORDANCE WITH THE PROJECT SPECIFICATIONS.
- 4. WHERE WATER LINE CROSSES UNDERNEATH STORM OR SANITARY SEWER, INSTALL FULL 20 LF STICK OF PIPE CENTERED ON SEWER OR STORM PIPE ALIGNMENT PER SECTION G, ON SHEET 6.
- 5. THE MAXIMUM LENGTH OF OPEN TRENCH ALLOWED AT THE END OF ANY WORK DAY SHALL BE 50 LINEAR FEET.
- 6. USE CONCRETE THRUST BLOCKING PER CITY STANDARDS FOR THRUST RESTRAINT ON PIPE DIAMETER SIZES 12-INCH AND SMALLER. USE RESTRAINED JOINT ON FITTINGS AND PIPE ACCORDING TO DETAIL 2 TABLE ON SHEET 5 (DWG D01) FOR THRUST
- 7. INSTALL PIPE IN CURVED ALIGNMENT WITH DEFLECTION ONLY AT MECHANICAL JOINT (MJ) COUPLINGS ON PLAIN PIPE ENDS AS NECESSARY TO APPROXIMATE THE DESIGNED CURVE RADIUS WITHOUT EXCEEDING A TOTAL DEFLECTION OF 4 DEGREES THROUGH ANY OF THE COUPLINGS. INSTALL COUPLINGS WITH EQUAL DEFLECTIONS C EACH JOINT OF THE COUPLING. CONTRACTOR SHALL NOT BEND PIPE. CONTRACTOR SHALL NOT DEFLECT (PULL) BELL AND SPIGOT JOINTS TO ACHIEVE CURVED PIPE
- 8. ALL FITTINGS, EXCEPT TAPPING SLEEVES, SHALL BE FACTORY FUSION BONDED EPOXY
- 9. ALL FITTINGS SHALL CONFORM TO CITY MATERIAL STANDARD SECTION 203-4.3 AND SHALL BE WRAPPED IN POLYETHYLENE ENCASEMENT AND SEALED IN ACCORDANCE WITH CITY OF DAVIS CONSTRUCTION STANDARDS.
- 10 CAUTION! EXISTING WATER SYSTEM CONTAINS NON-POTABLE WATER NEWLY CONSTRUCTED PIPELINES LARGER THAN 10—INCH DIAMETER SHALL BE FILLED ONLY FROM CITY WATER SYSTEM. UPON COMPLETION OF TESTING AND CONNECTION OF NEW PORTIONS OF WATER SYSTEM AND DISCONNECTION OF EXISTING WELLS. CONTRACTOR SHALL SYSTEMATICALLY FLUSH ALL MAINS AND SERVICE PIPING PER CONTRACT SPECIFICATIONS TO REMOVE ALL NON-POTABLE WATER FROM WATER SYSTEM.
- 11 CONTRACTOR SHALL POTHOLE ALL WATER SYSTEM TIE-IN POINTS PRIOR TO REGINNING TRENCHING FOR PIPE INSTALLATION. UPSIZED PIPELINE REPLACEMENTS ARE INTENDED TO MATCH CENTERLINE GRADES OF EXISTING PIPES THAT ARE BEING REPLACED
- 12. CONTRACTOR SHALL REMOVE PIPE TO BE ABANDONED TO A DISTANCE OF NOT LESS THAN 2 FEET FROM PIPE REMAINING IN SERVICE. CONTRACTOR SHALL PROVIDE SURVEYED POSITIONS OF ABANDONED PIPE LENGTHS WITH AS—BUILT RECORDS.
- 13. CUSTOMER SERVICE OUTAGES FOR WATER MAIN WORK SHALL BE LIMITED TO A SINGLE 4—HOUR PERIOD, EXCEPT IN—PLACE WATER MAIN REPLACEMENT SEGMENTS MAY EXTEND THE OUTAGE UP TO 6—HOURS, IF THE CONTRACTOR IS WORKING CONTINUOUSLY TO KEEP DURATION AS SHORT AS POSSIBLE.

GENERAL NOTES

- 1. ALL WATER SYSTEM IMPROVEMENTS SHALL BE PERFORMED IN ACCORDANCE WITH CITY OF DAVIS STANDARD DETAILS AND SPECIFICATIONS MOST RECENT EDITION. ALL OTHER CONSTRUCTION AND MATERIALS SHALL CONFORM TO COUNTY OF YOLO STANDARDS.
- 2. THE CONTRACTOR SHALL NOT BEGIN ANY WORK SHOWN ON THESE PLANS UNTIL THE APPROVAL OF THE COUNTY IS AFFIXED AND HEREON AND ALL APPLICABLE PERMITS HAVE BEEN OBTAINED. CONSTRUCTION ENCROACHMENT PERMIT WILL BE ISSUED TO THE CONTRACTOR FOR WORK IN COUNTY RIGHT-OF-WAY AT NO COST TO THE CONTRACTOR.
- 3. CONTRACTOR SHALL CALL UNDERGROUND SERVICE ALERT (USA) 800-227-2600 AT LEAST TWO WORKING DAYS PRIOR TO ANY EXCAVATION.
- 4. EXISTING UTILITIES ARE PLOTTED FROM AVAILABLE RECORDS. CONTRACTOR SHALL LOCATE AND PRESERVE ALL FACILITIES INCLUDING SEWER, GAS, IRRIGATION, POWER, STREET LIGHTS, TELEPHONE AND OTHERS WHICH MAY BE IN AREA OF CONSTRUCTION. CONTRÁCTOR SHALL EXPOSE AND VERIFY LOCATIONS AND ELEVATIONS OF EXISTING UNDERGROUND UTILITIES PRIOR TO CONSTRUCTION OF THE NEW IMPROVEMENTS OR CONNECTING TO OR IN THE VICINITY OF THE SAME
- 5. CONTRACTOR SHALL BE RESPONSIBLE FOR FIELD SURVEYING AND ESTABLISHING GRADE STAKING. STAKING SHALL BE DONE BY A REGISTERED CIVIL ENGINEER OR LICENSED LAND SURVEYOR COMPLYING WITH THE STATE REQUIREMENTS.
- 6. NO PAVEMENT WORK WILL OCCUR WITHIN THE ROAD RIGHT-OF-WAY PRIOR TO COMPLETION OF ANY NECESSARY UTILITY UNDERGROUND WORK WITHIN THAT RIGHT-OF-WAY.
- 7. CONTRACTOR SHALL BE RESPONSIBLE FOR THE PROTECTION OF ALL EXISTING SURVEY MONUMENTS AND/OR OTHER SURVEY MARKERS DURING CONSTRUCTION. ALL MONUMENTS OR MARKERS DESTROYED DURING CONSTRUCTION SHALL BE REPLACED BY A LICENSED CALIFORNIA LAND SURVEYOR AT THE CONTRACTOR'S EXPENSE.
- 8. IT IS INTENDED THAT THESE PLANS REQUIRE ALL LABOR AND MATERIALS NECESSARY FOR COMPLETION OF WORK IN ACCORDANCE WITH THEIR TRUE INTENT AND PURPOSE. CONTRACTOR SHALL NOTIFY ENGINEER IMMEDIATELY REGARDING ANY DISCREPANCIES OR AMBIGUITIES WHICH MAY EXIST IN PLANS OR SPECIFICATIONS. ENGINEER'S INTERPRETATION OR CORRECTION THEREOF SHALL BE FINAL AND CONCLUSIVE. WHERE PLANS OR SPECIFICATIONS DESCRIBE PORTIONS OF WORK IN GENERAL TERMS BUT NOT IN COMPLETE DETAILS, IT IS UNDERSTOOD THAT ONLY THE BEST GENERAL PRACTICE
- 9. MATERIALS SUBMITTALS FOR MATERIAL INCORPORATED INTO THE WORK INCLUDING, BUT NOT LIMITED TO AGGREGATE BASE, HOT MIX ASPHALT, CONCRETE, SAND, AND ALL WAT SYSTEM PIPE, FITTINGS, COMPONENTS AND APPURTENANCES SHALL BE SUBMITTED TO THE COUNTY AT LEAST TWO WEEKS PRIOR TO DELIVERY OF MATERIALS TO THE SITE.

GENERAL NOTES (CONTINUED)

- 10. TESTING IS REQUIRED FOR TRENCH BACKFILL, GRADE COMPACTION, CONCRETE SLUMP, AND CONCRETE STRENGTH. TESTING SHALL BE PROVIDED BY INDEPENDENT LABORATORY APPROVED BY THE COUNTY AND HIRED BY THE CONTRACTOR. ALL TESTING SHALL BE PAID BY CONTRACTOR. THE QUANTITY OF RE-TESTING SHALL BE AS REQUIRED BY THE COUNTY. ALL TEST RESULTS SHALL BE SUBMITTED TO THE COUNTY WITHIN THREE (3) WORKING DAYS.
- CONTRACTORS SHALL BE RESPONSIBLE FOR COORDINATING THEIR OPERATIONS WITH ALL REQUIRED MATERIALS TESTING SERVICES AS REQUIRED BY THE YOLO COUNTY IMPROVEMENT STANDARDS AND THE COUNTY INSPECTOR. EACH PHASE OF CONSTRUCTION SHALL BE TESTED AND APPROVED BY THE COUNTY INSPECTOR PRIOR TO PROCEEDING TO SUBSEQUENT PHASES.
- CONTRACTOR SHALL, AT ALL TIMES, KEEP WORK AREA IN A NEAT AND SAFE CONDITION. UPON COMPLETION OF ANY PORTION OF WORK, CONTRACTOR SHALL PROMPTLY REMOVE ALL ITS EQUIPMENT AND SURPLUS MATERIALS, UNLESS NOTED OTHERWISE. CONTRACTOR SHALL, AT HIS/HER OWN EXPENSE, DISPOSE OF ALL RUBBISH, UNUSED MATERIALS AND OTHER EQUIPMENT BELONGING TO OR USED IN PERFORMANCE OF WORK, TO THE SATISFACTION OF THE ENGINEER. AFTER COMPLETION OF THE PROJECT, CONTRACTOR SHALL LEAVE THE PROJECT SITE IN EQUAL OR BETTER CONDITION THAN WHEN CONSTRUCTION BEGAN.
- CONTRACTOR SHALL ASSUME SOLE AND COMPLETE RESPONSIBILITY FOR JOB SITE CONDITION AND THE PROTECTION OF PUBLIC AND PRIVATE PROPERTY ADJACENT TO THE WORK SITE DURING THE CONSTRUCTION OF THE PROJECT.
- ALL CONSTRUCTION AND MATERIAL DELIVERY ROUTES SHALL BE MONITORED DURING THE PROJECT FOR ANY DAMAGE AND DEBRIS ATTRIBUTED TO THE PROJECT VEHICLES ALL DAMAGE AND DEBRIS AS A RESULT OF THE PROJECT SHALL BE REPAIRED AND CLEANED PER COUNTY STANDARDS
- CONTRACTOR SHALL BE RESPONSIBLE FOR COMPLIANCE WITH ALL CURRENTLY APPLICABLE SAFETY LAWS OF ANY JURISDICTIONAL BODY. CONTRACTOR IS DIRECTED APPLICABLE SAFEIT LAWS OF ANY JOINSDICTIONAL BODY. CONTRACTOR IS DIRECTO CONTRACT STATE OF CALLFORNIA, INDUSTRIAL RELATION DEPARTMENT (209) 948-7763. CONTRACTOR SHALL BE RESPONSIBLE TO PROVIDE ALL BARRICADES, SAFETY DEVICES AND CONTROL OF TRAFFIC WITHIN CONSTRUCTION AREAS AS NECESSARY FOR PERFORMANCE OF CONTRACT WORK.
- CONTRACTOR SHALL NOT DETOUR ANY TRAFFIC OTHER THAN AT LOCATIONS AND FOR CONTRACTOR SHALL NOT DETOUR ANY TRAFFIC OTHER THAN AT LOCATIONS AND FOR DURATIONS NOTED ON THESE PLANS. CONTRACTOR SHALL NOT DETOUR ANY TRAFFIC WITHOUT PRIOR WRITTEN APPROVAL OF THE DETOUR ROUTE AND AN APPROVED ENGINEERED TRAFFIC CONTROL PLAN FOR THE DETOUR SINGLE LANE CLOSURES WILL BE ALLOWED WITH FLAGGED TRAFFIC AND AN APPROVED, ENGINEERED TRAFFIC CONTROL PLAN. ANY PROPOSAL FOR CLOSURE OF A TRAFFIC LANE ON A COUNTY STREET SHALL BE SUBMITTED WITH THE TRAFFIC CONTROL PLAN TO THE ENGINEER IN WRITING AT LEAST TWO WEEKS IN ADVANCE OF THE PROPOSED CLOSURE. ACCESS TO ADJACENT PROPERTIES SHALL BE PROVIDED AT ALL TIMES.
- PROPER TRAFFIC CONTROL SHALL BE MAINTAINED AT ALL TIMES DURING CONSTRUCTION IN ACCORDANCE WITH COUNTY'S ADOPTED TRAFFIC MANUAL.

 CONTRACTOR SHALL SUBMIT TRAFFIC CONTROL PLANS TO THE COUNTY FOR REVIEW

 AT PRE-CONSTRUCTION MEETING AND OBTAIN ACCEPTANCE BEFORE STARTING ANY SAFE VEHICULAR, BICYCLE, AND PEDESTRIAN ACCESS SHALL BE PROVIDED AT
- THE CONTRACTOR SHALL MAINTAIN CONTINUOUS TEMPORARY TRAFFIC BARRICADES WITH OPERABLE FLASHING DEVICES, SPACED AT INTERVALS OF NOT TO EXCEED 50 FEET WHENEVER THE WORK AREA IS ADJACENT TO AN EXISTING TRAFFIC LANE AND THERE IS A PAVEMENT CUT, TRENCH, OR DITCH WHICH IS OVER 2 INCHES IN DEPTH OR IF THE TRAFFIC LANE USED BY VEHICLES IS NOT PAVED. IF THE CUT, TRENCH, OR DITCH IS MORE THAN 10 FEET FROM TRAFFIC LANE, THEN THE BARRICADE SPACING MAY BE GREATER, PROVIDED THAT IT DOES NOT EXCEED 200 FEET
- PRIOR TO EXCAVATION OF TRENCHES 5 FFFT OR DEEPER. THE CONTRACTOR SHALL SUBMIT TO THE PUBLIC WORKS DEPARTMENT INSPECTOR A COPY OF THE COMPANY'S INFORMING CAL/OSHA OF THE TIME THE TRENCHING IS COMMENCING AND THE LOCATION OF THE WORK. ANNUAL CAL/OSHA EXCAVATION PERMIT AND A COPY OF THE COMPANY'S LETTER
- CONTRACTOR SHALL COORDINATE WITH PG&E TO ALLOW PG&E PERSONNEL TO BE PRESENT WHEN EXCAVATING WITHIN 10 FEET OF EXISTING GAS MAIN.
- CONTRACTOR SHALL COORDINATE WITH WASTE MANAGEMENT SERVICES AND FACILITATE THE COLLECTION SERVICES THROUGH ANY ACTIVE CONSTRUCTION ZONES.
- CONTRACTOR SHALL NOT DISPOSE OF CHLORINATED OR OTHER CHEMICALLY TREATED WATER INTO ANY DRAINAGE SYSTEM.
- FOR HOT MIX ASPHALT REPLACEMENT, AMBIENT TEMPERATURE SHALL NOT BE LESS THAN 55 DEGREES FAHRENHEIT AND RISING IN THE SHADE.
- CONTRACTOR SHALL TAKE PRE-CONSTRUCTION AND POST-CONSTRUCTION PHOTOS AND VIDEOS OF ALL WORK AREAS AND SUBMIT THEM TO THE COUNTY PER CONTRACT
- ALL PAVEMENT STRIPES, MARKERS, AND MARKINGS, INCLUDING BLUE MARKERS NOTING FIRE HYDRANT POSITIONS, SHALL BE REPLACED IN-KIND IF DAMAGED OR REMOVED
- EXISTING ELECTRICAL CONDUITS FOR STREET LIGHTING IN NORTH DAVIS MEADOWS ARE NOT SHOWN DUE TO LACK OF RECORD DATA. COORDINATE DIRECTLY WITH COUNTY PUBLIC WORKS DURING USA NOTIFICATION AND MARKING PROCESS TO GET STREET
- ALL TRENCH WORK SHALL BE PERFORMED IN ACCORDANCE WITH THE CITY AND COUNTY STANDARD DETAILS AS SHOWN AND MODIFIED IN THESE PLANS.
- CONTRACTOR SHALL PROVIDE RECORD DRAWINGS TO THE COUNTY, INCLUDING ALL AS-BUILT, FIELD SURVEY MEASUREMENTS FOR ALL INVERTS, ROADSIDE DRAINAGE DITCHES, APPURTENANCE LOCATIONS, ROAD REPAIRS, OR OTHER FACILITIES AS REQUIRED BY THE COUNTY ENGINEER.
- COORDINATE FINAL LOCATION OF ALL PIPELINE APPURTENANCES WITHIN COUNTY RIGHT-OF-WAY WITH COUNTY INSPECTOR PRIOR TO INSTALLATION.

GENERAL NOTES (CONTINUED)

- WHERE CONSTRUCTION REMOVES, UNDERMINES, OR DAMAGES EXISTING PAVEMENTS 30. WITHIN THE EXISTING VEHICLE TRAVEL LANE, CONTRACTOR SHALL PERFORM A FULL WIDTH OF 0.15' DEEP GRIND AND REPAVE OF ENTIRE LANE TO 10' BEYOND THE EXCAVATION / DAMAGE LIMITS IN EACH DIRECTION. FOR ROADS OTHER THAN COUNTY , THIS REQUIREMENT APPLIES ONLY TO DAMAGE BEYOND THE TRENCH TEE
- CONTRACTOR SHALL IDENTIFY ALL PLANNED ACCESS POINTS FOR WORK OUTSIDE OF EXISTING ROADWAYS IN ADVANCE AND INCLUDE THE LOCATIONS IN THE SWPPP AND PROVIDE TRAFFIC CONTROL PLANS SUBJECT TO COUNTY APPROVAL FOR INGRESS/EGRESS CONTROLS.

CONSTRUCTION NOTES:

- 1 INSTALL WATER PIPE (DIAMETER/LENGTH)
- 2 INSTALL GATE VALVE (SIZE)
- 3 INSTALL HORIZONTAL BEND (SIZE/ANGLE)
- 4 INSTALL VERTICAL BEND (SIZE/ANGLE)
- 5 INSTALL TEE (SIZE/SIZE)
- 6 INSTALL CUT-IN CROSS PER DETAIL 9, SHT D05 (SIZE)
- 7 INSTALL REDUCER (SIZE/SIZE)
- 8 INSTALL BUTTERFLY VALVE (SIZE)
- 9 INSTALL WATER SERVICE LATERAL (SIZE)
- INSTALL 1-INCH METER WITH VALVES, ANODE AND BOX ON EXISTING SERVICE (SIZE) PER DETAIL 3, SHT DO3
- INSTALL METER WITH VALVES, ANODE AND BOX PER DETAIL 4, SHT DO3 AND CONNECT TO EXISTING IRRIGATION SERVICE. LOCATE EXISTING PIPE AT EXISTING BACKFLOW PREVENTER AND INSTALL METER ON SUPPLY
- SIDE OF BACKFLOW (SIZE) LOCATE AND EXPOSE EXISTING SERVICE VALVE. SET NEW BOX PER MODIFIED STANDARD PLAN 101-3 ON SHT D04.
- INSTALL HOT-TAPPED TEE ON EXISTING WATER MAIN
- 13 (MAIN SIZE/TEE SIZE)
- 14 INSTALL CUT-IN TEE PER DETAIL 8, SHT D05 (SIZE/SIZE)
- 15 INSTALL NEW FIRE HYDRANT ASSEMBLY WITH CONCRETE ANCHOR PER CITY STANDARD PLAN 101-1. (SEE SHT D07)
- REMOVE EXISTING FIRE HYDRANT ASSEMBLY, LATERAL AND VALVE. INSTALL BLIND FLANGE WHERE VALVE WAS REMOVED
- install water sampling station complete with 1-inch service per city of davis std plan 101-10
- 18 INSTALL COMBINATION AIR/VACUUM VALVE ASSEMBLY COMPLETE WITH 1-INCH SERVICE PER DETAIL 5, SHT D04
- REMOVE AND REPLACE 6-INCH CONCRETE PATH TO AT LEAST 1-FOOT BEYOND TRENCH EXCAVATION LIMITS. SAWCUT THE REPLACEMENT LIMITS PERPENDICULAR TO THE EXISTING PATH. WHERE LIMITS PER THIS REQUIREMENT ARE WITHIN 2-FEET OF AN EXISTING JOINT, EXTEND SAWCUT & REPLACEMENT LIMIT TO THE EXISTING JOINT
- 20 INSTALL 6-INCH BYPASS WITH VALVES PER DETAIL 6, SHT D05
- INSTALL 6-INCH BYPASS WITH VALVES AND HOT-TAP
- 21 PER DETAIL 10, SHT D05
- INSTALL 16-INCH RJ DUCTILE IRON WATER PIPE IN 27-INCH STEEL 22 INSTALL TO-INCH NO DOCTREE THOSE WITHOUT PER DETAIL 11, SHT DOG
- 23 REMOVE EXISTING BACKFLOW PREVENTER AND INSTALL BACKFLOW PREVENTION ASSEMBLY PER CITY OF DAVIS STANDARD PLAN 101-11 (SIZE)
- 24 INSTALL 4-INCH LOW-POINT BLOW OFF ASSEMBLY PER DETAIL 7, SHT D05
- 25 CUT, CAP AND ABANDON EXISTING DISCONNECTED WATER
- 26 DELETED
- 27 DELETED
- INSTALL 1-INCH SERVICE THROUGH ANGLE METER STOP VALVE WITH METER BOX AND PIPE STUB AFTER VALVE PER CITY STANDARD FOR FUTUR PRESSURE SENSOR/TRANSDUCER (BY OTHERS), NO METER REQUIRED
- [29] INSTALL BLUE COMPOSITE UTILITY MARKER WITH DECAL STATING "CAUTION WATER PIPELINE" PER CITY STANDARDS.
- INSTALL BRASS MARKER IN 8-INCH CONCRETE CYLINDER MARKED WITH "CITY OF DAVIS WATER MAIN". INSTALL PER CITY STANDARD, EXCEPT SET MARKER FLUSH WITH EXISTING GRADE.

BID DOCUMENTS

2 of 36

DESIGN ENGINEER

ASA J. UTTERBACK ENGINEER'S NAME DATE JANUARY 12, 2018 P.E. C57700 REGISTRATION EXPIRES 12/31/2019




2020 Research Park Drive Suite 100 Davis, California 95618 (530) 756-5905 FAX (530) 756-599


COUNTY OF YOLO DEPARTMENT OF COMMUNITY SERVICES IMPROVEMENT PLANS FOR NORTH DAVIS MEADOWS WATER SYSTEM CONSOLIDATION PROJECT

SCALE DWG NO AS SHOWN G02 SHEET NO DATE: 12/06/2018

GENERAL NOTES

DRAWN CHECKED KLW NO. BY DATE REVISION APP'D DATE

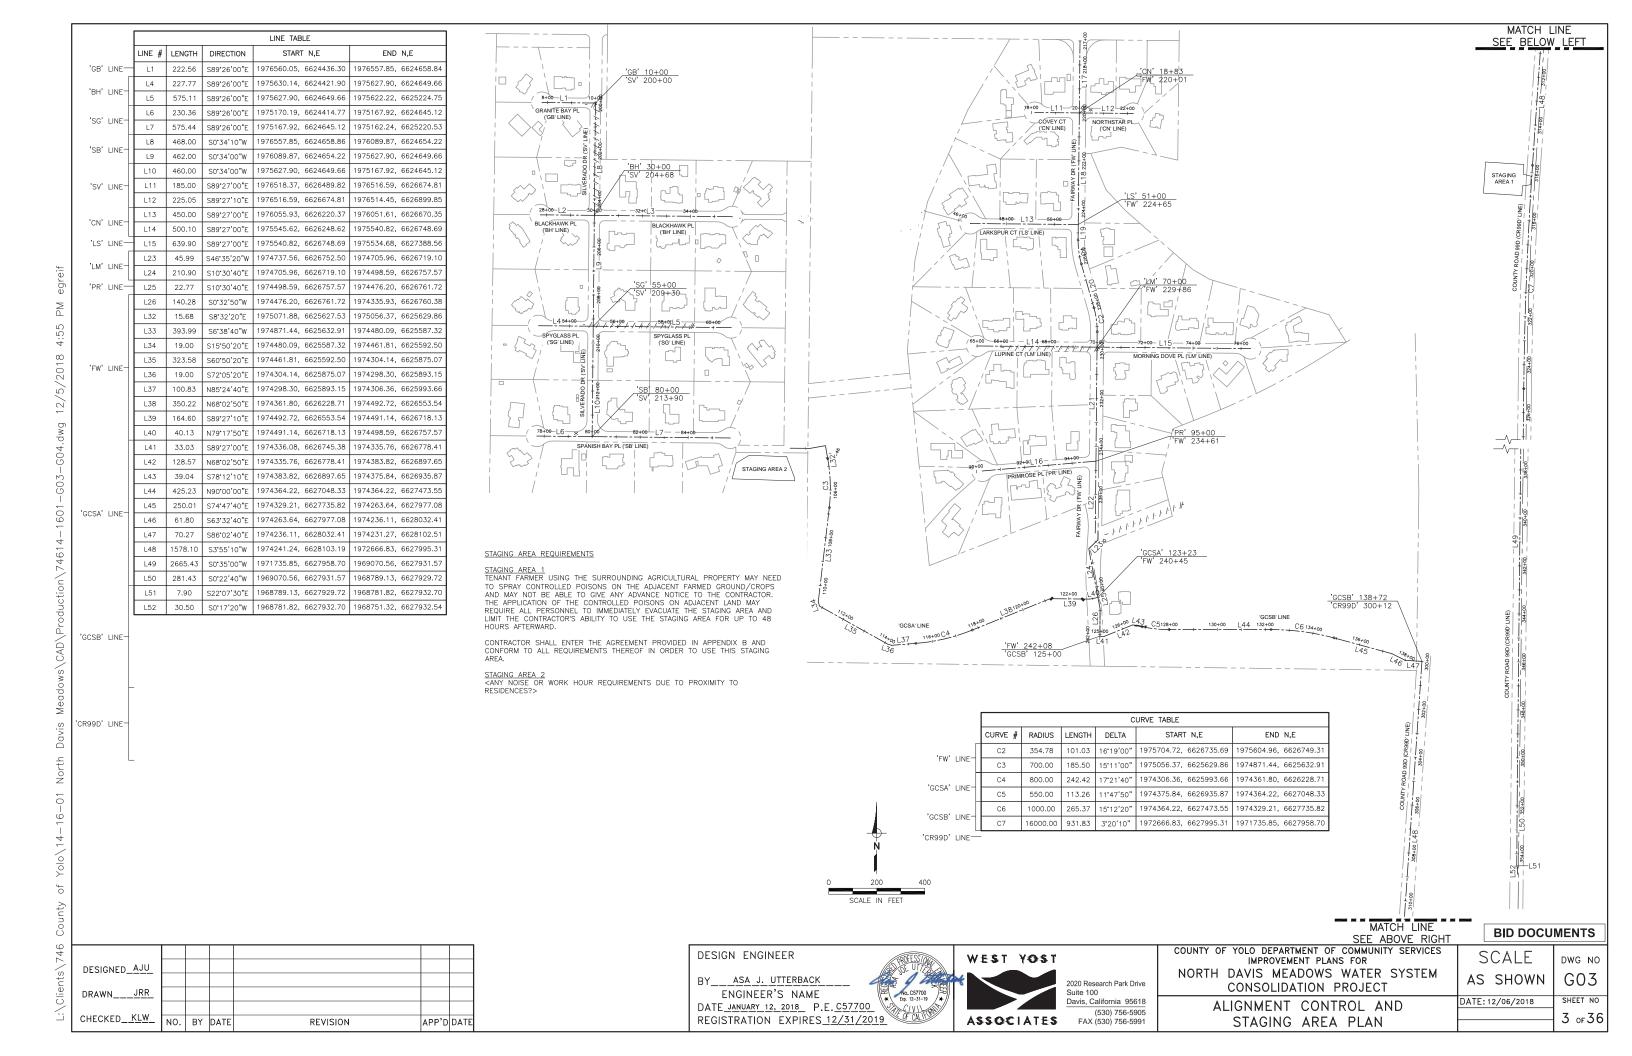

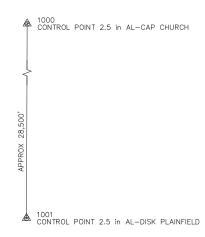

		P	OTHOLE TABLE		
PH#	STREET NAME	SHEET #	TYPE OF UTILITY	UTILITY SIZE	DEPTH
1	COVEY CT	C01	WATER	6"	3.9'
2	COVEY CT	C01	WATER	6"	3.9'
3	COVEY CT	C01	WATER	6"	3.9'
4	BLACKHAWK PL	C02	WATER	6"	4.4'
5	BLACKHAWK PL	C02	WATER	6"	4.4'
6	BLACKHAWK PL	C02	SSFM	2"	4.9'
7	BLACKHAWK PL	C02	GAS	4"	3.6'
8	BLACKHAWK PL	C02	ELECTRIC	4"	3.5'
9	SPYGLASS PL	C03	WATER	6"	4.8'
10	SPYGLASS PL	C03	WATER	6"	4.8'
11	LARKSPUR CT	C07	WATER	6"	4.2'
12	LARKSPUR CT	C07	WATER	6"	4.3'
13	LARKSPUR CT	C07	WATER	6"	4.3'
14	LARKSPUR CT	C07	SSFM	3"	6.2'
15	LARKSPUR CT	C07	COMMUNICATION	4"	4.8'
16	LUPINE CT	C08	SSFM	3"	6.4'
17	SPANISH BAY	C04	WATER	6"	4.9'
18	SPANISH BAY	C04	WATER	6"	3.2'
19	RD 99D	C19	GAS	4"	5.9' (1
20	RD 99D	C19	COMMUNICATION	1"	6.5' (1
21	RD 99D	C20	GAS	6"	7.7'
22	RD 99D	C20	COMMUNICATION	6"	8.0'
23	RD 99D	C21	GAS	.75"	6.9'

POTHOLE NOTE 1: NOTED DEPTH IS RELATIVE TO ADJACENT EDGE OF PAVEMENT

POTHOLE DATA


DESIGNED_AJU						
520,0,,25						
DRAWNJRR_						
CHECKED_KLW_	NO.	BY	DATE	REVISION	APP'D	DATE

COORDINATES SHOWN ARE CCS83 ZONE2, EPOCH 2002.53, AND ARE BASED ON THE "YOLO COUNTY GPS SUBSIDENCE NETWORK", SUBMITTED FEBRUARY 26, 2003. ELEVATIONS SHOWN ARE BASED ON THE "YOLO COUNTY GPS SUBSIDENCE NETWORK" HOLDING PLAINFIELD FOR THE VERTICAL ADJUSTMENT.

COORDINATES AND ELEVATIONS SHOWN ARE IN U.S. SURVEY FEET.

AN AVERAGE COMBINED FACTOR OF 0.99995 WILL BE USED FOR THIS PROJECT. DIVIDE GRID DISTANCES BY 0.99995 TO OBTAIN GROUND DISTANCES.

	POINT TABLE								
POINT #	NORTHING	EASTING	ELEVATION	DESCRIPTION					
1000	2003455.66	6618054.62	0.00	CONTROL POINT 2.5 in AL-CAP CHURCH					
1001	1974876.43	6617913.18	65.49	CONTROL POINT 2.5 in AL-DISK PLAINFIELD					
2001	1976913.88	6623385.99	59.20	FLIGHT CROSS					
2002	1976894.27	6625562.33	52.93	FLIGHT CROSS					
2003	1976906.53	6627229.78	52.10	FLIGHT CROSS					
2004	1976890.13	6628779.36	55.35	FLIGHT CROSS					
2005	1974268.51	6623389.67	57.87	FLIGHT CROSS					
2006	1974245.95	6625230.70	55.16	FLIGHT CROSS					
2007	1974213.76	6627173.68	53.11	FLIGHT CROSS					
2008	1973718.02	6628062.14	53.07	FLIGHT CROSS					
2009	1973721.41	6628376.66	52.36	FLIGHT CROSS					
2010	1971585.24	6626999.97	54.11	FLIGHT CROSS					
2011	1971569.32	6627957.45	53.33	FLIGHT CROSS					
2012	1971552.32	6628265.18	53.77	FLIGHT CROSS					
2013	1968399.73	6626970.64	48.76	FLIGHT CROSS					
2014	1968345.99	6627926.72	49.14	FLIGHT CROSS					
2015	1968374.50	6628954.69	48.03	FLIGHT CROSS					

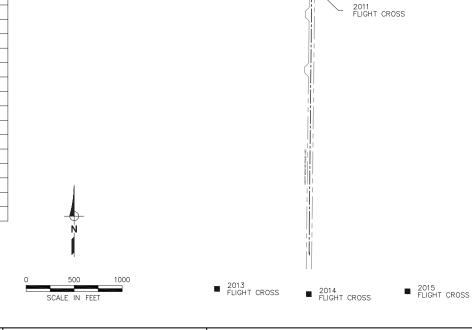

DESIGN ENGINEER



2020 Research Park Drive Suite 100 Davis, California 95618 (530) 756-5905 FAX (530) 756-5991

2002 FLIGHT CROSS

2006 FLIGHT CROSS - FW 242+08 'GCSB' 125+00

■ 2003 FLIGHT CROSS

GCSA' 123+23 FW' 240+45

■ 2010 FLIGHT CROSS

■ 2007 FLIGHT CROSS

2009
FLIGHT CROSS


2008
FLIGHT CROSS

■ 2012 FLIGHT CROSS

COUNTY OF YOLO DEPARTMENT OF COMMUNITY SERVICES
IMPROVEMENT PLANS FOR
NORTH DAVIS MEADOWS WATER SYSTEM
CONSOLIDATION PROJECT
SURVEY CONTROL PLAN
AND POTHOLE DATA


SCALE DWG NO
AS SHOWN GO4


DATE: 12/06/2018 SHEET NO
4 of 36

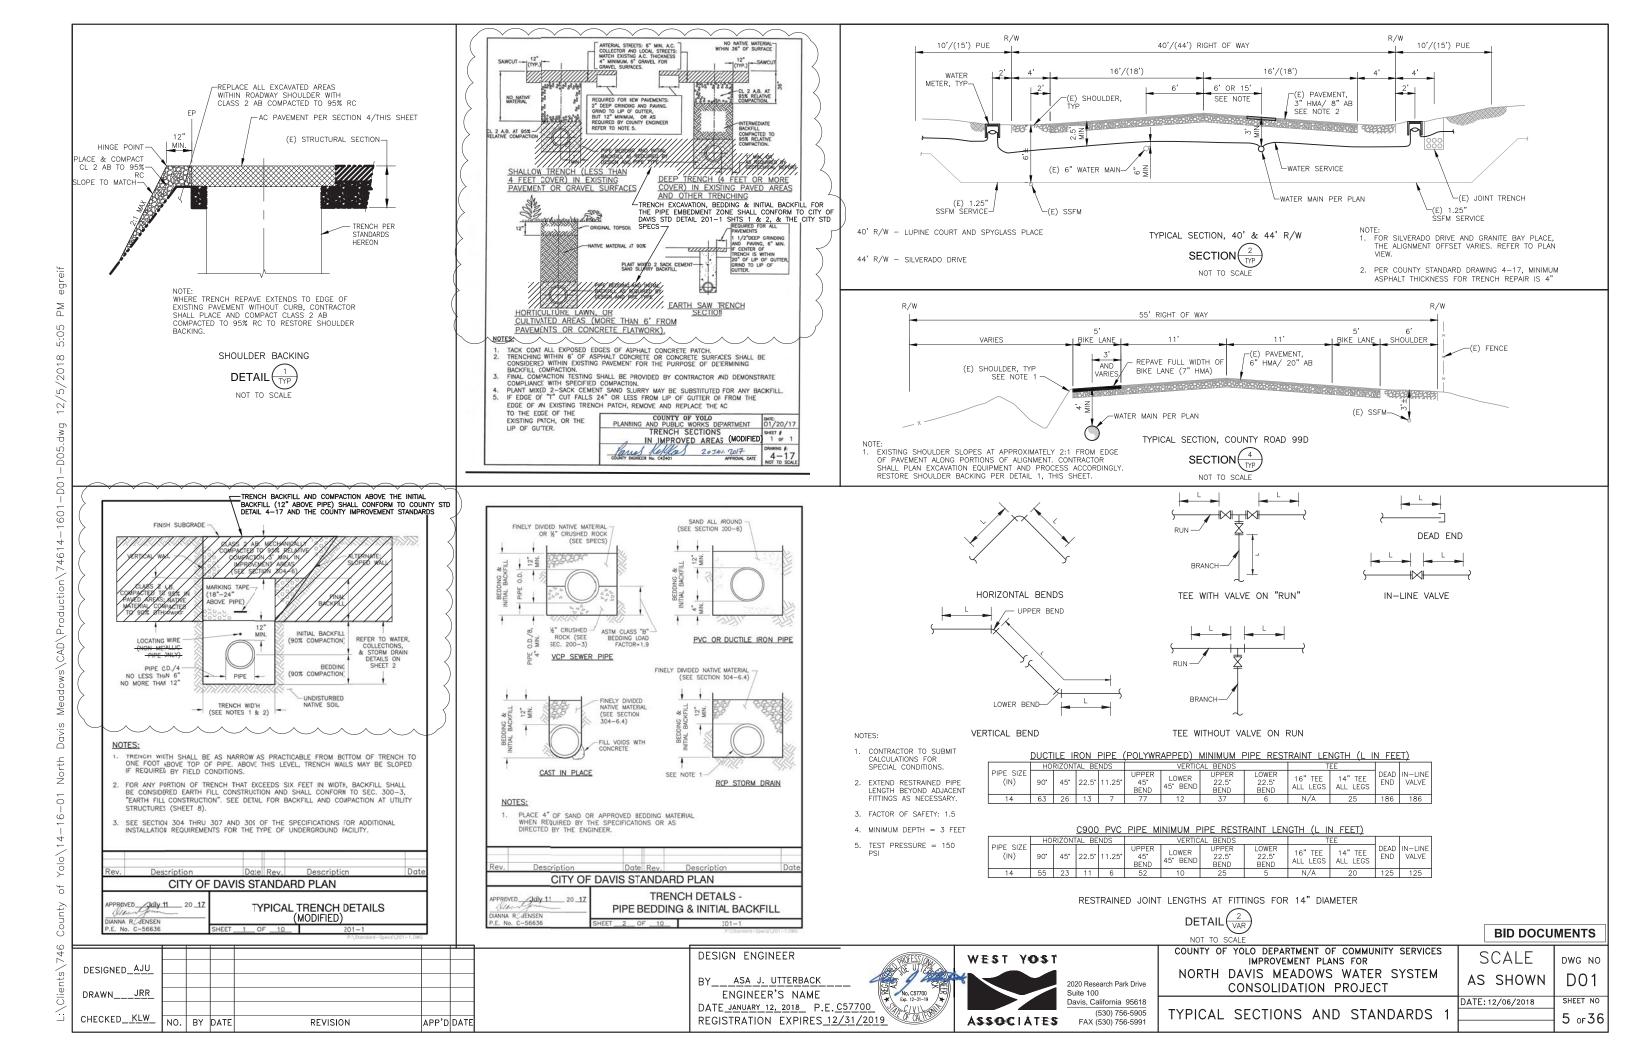



L:\Clients\746 County of Yolo\14-16-01 North Davis Meadows\CAD\Production\74614-1601-D01-D05.dwg 12/5/2018 5:05 PM egreif

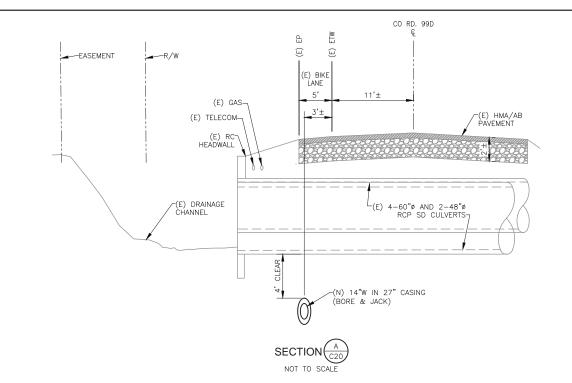

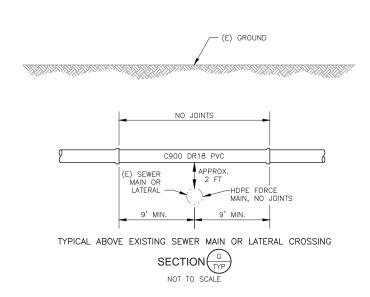

DESIGNED_AJU_						
DRAWNJRR_						
CHECKED_KLW_	NO.	BY	DATE	REVISION	APP'D	DATE

DESIGN ENGINEER

BY ASA J. UTTERBACK

ENGINEER'S NAME

DATE JANUARY 12, 2018 P.E. C57700

REGISTRATION EXPIRES 12/31/2019

WEST YOST

2020 Research Park Drive
Suite 100
Davis, California 95618
(530) 756-5905
FAX (530) 756-5991


COUNTY OF YOLO DEPARTMENT OF COMMUNITY SERVICES
IMPROVEMENT PLANS FOR
NORTH DAVIS MEADOWS WATER SYSTEM
CONSOLIDATION PROJECT


TYPICAL SECTIONS


SCALE DWG NO DO2


DATE: 12/06/2018 SHEET NO 6 of 36

BID DOCUMENTS

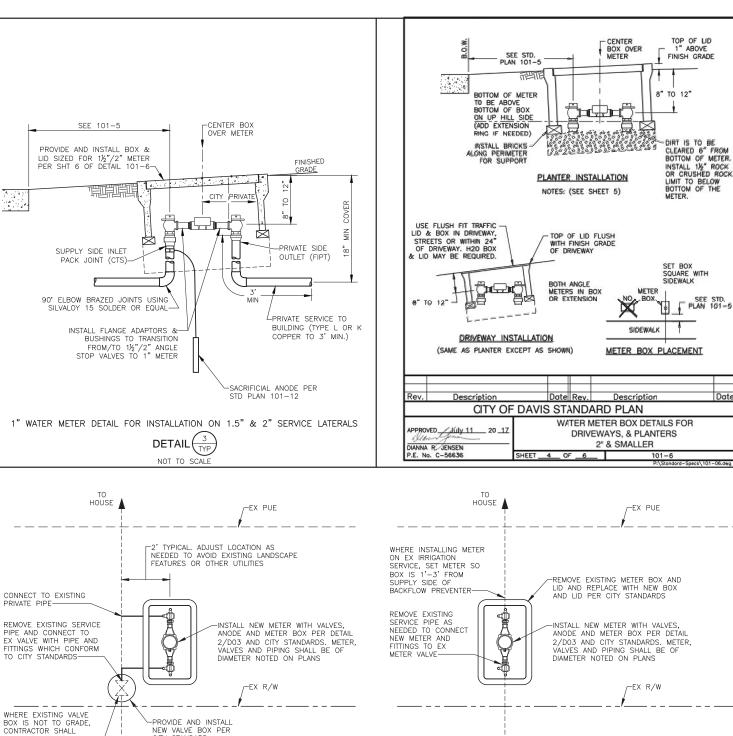

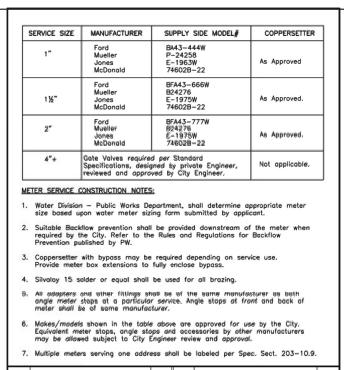

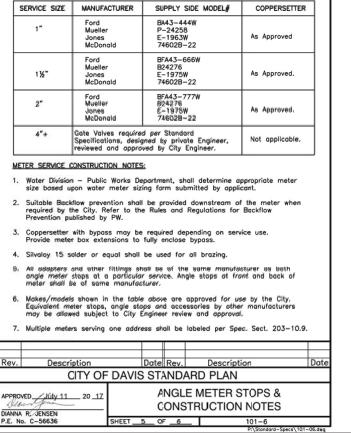

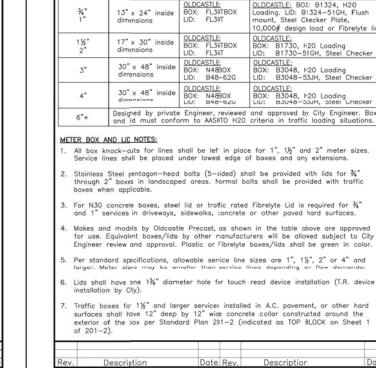


PPROVED July 11 20 17


BOX SIZE

LANDSCAPED AREAS

TRAFFIC AREAS

METER SIZE

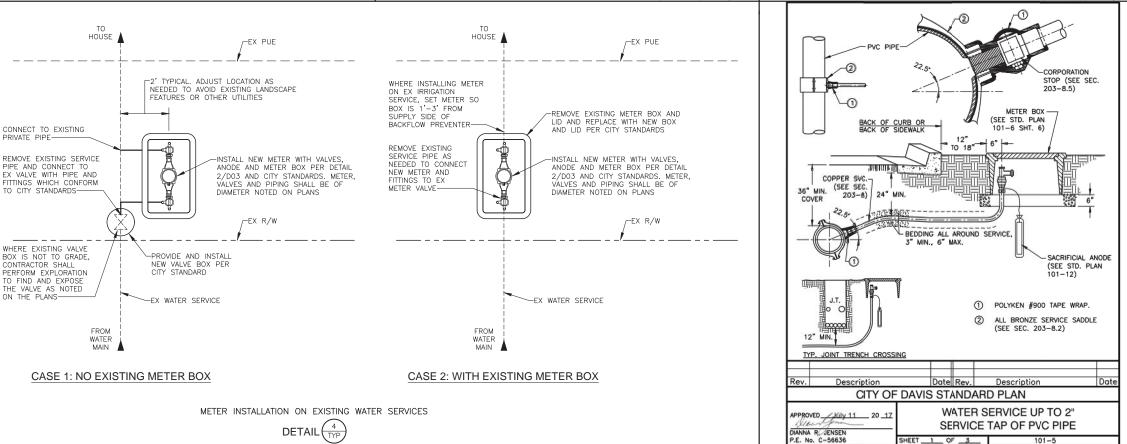

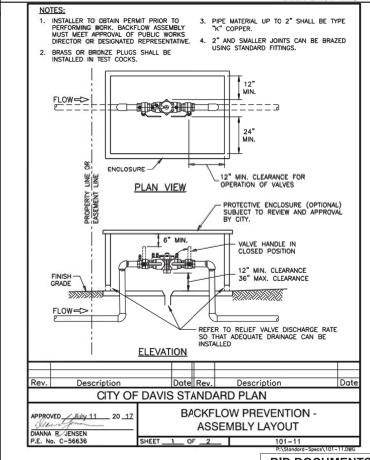

CITY OF DAVIS STANDARD PLAN

WATER METER - BOXES AND LIDS

BID DOCUMENTS

DESIGNED_AJU DRAWN CHECKED KLW NO. BY DATE REVISION APP'D DATE

NOT TO SCALE

12/5/

ON THE PLANS-

DESIGN ENGINEER

ASA J. UTTERBACK ENGINEER'S NAME DATE JANUARY 12, 2018 P.E. C57700 REGISTRATION EXPIRES 12/31/2019 WEST YOST ASSOCIATES

SHEET 1 OF 3


2020 Research Park Drive Suite 100 Davis, California 95618 (530) 756-5905 FAX (530) 756-5991


COUNTY OF YOLO DEPARTMENT OF COMMUNITY SERVICES IMPROVEMENT PLANS FOR NORTH DAVIS MEADOWS WATER SYSTEM CONSOLIDATION PROJECT


SCALE DWG NO AS SHOWN D03 DATE: 12/06/2018

WATER SERVICE DETAILS

SHEET NO 7 оғ36

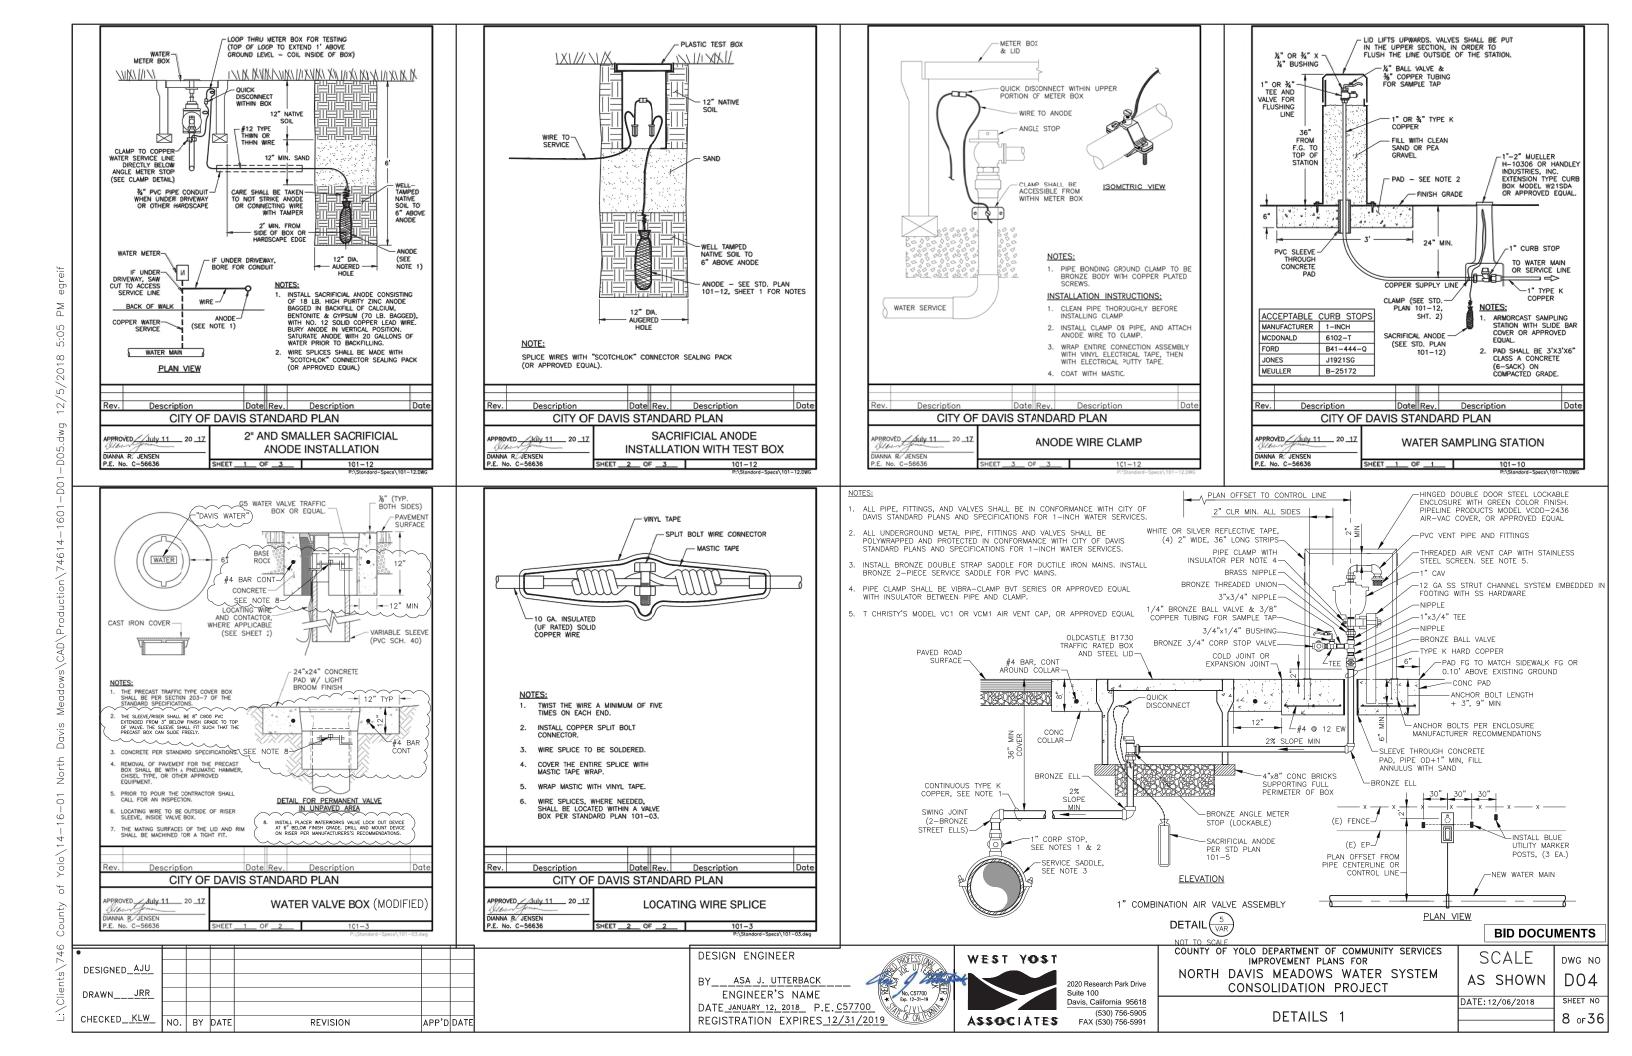


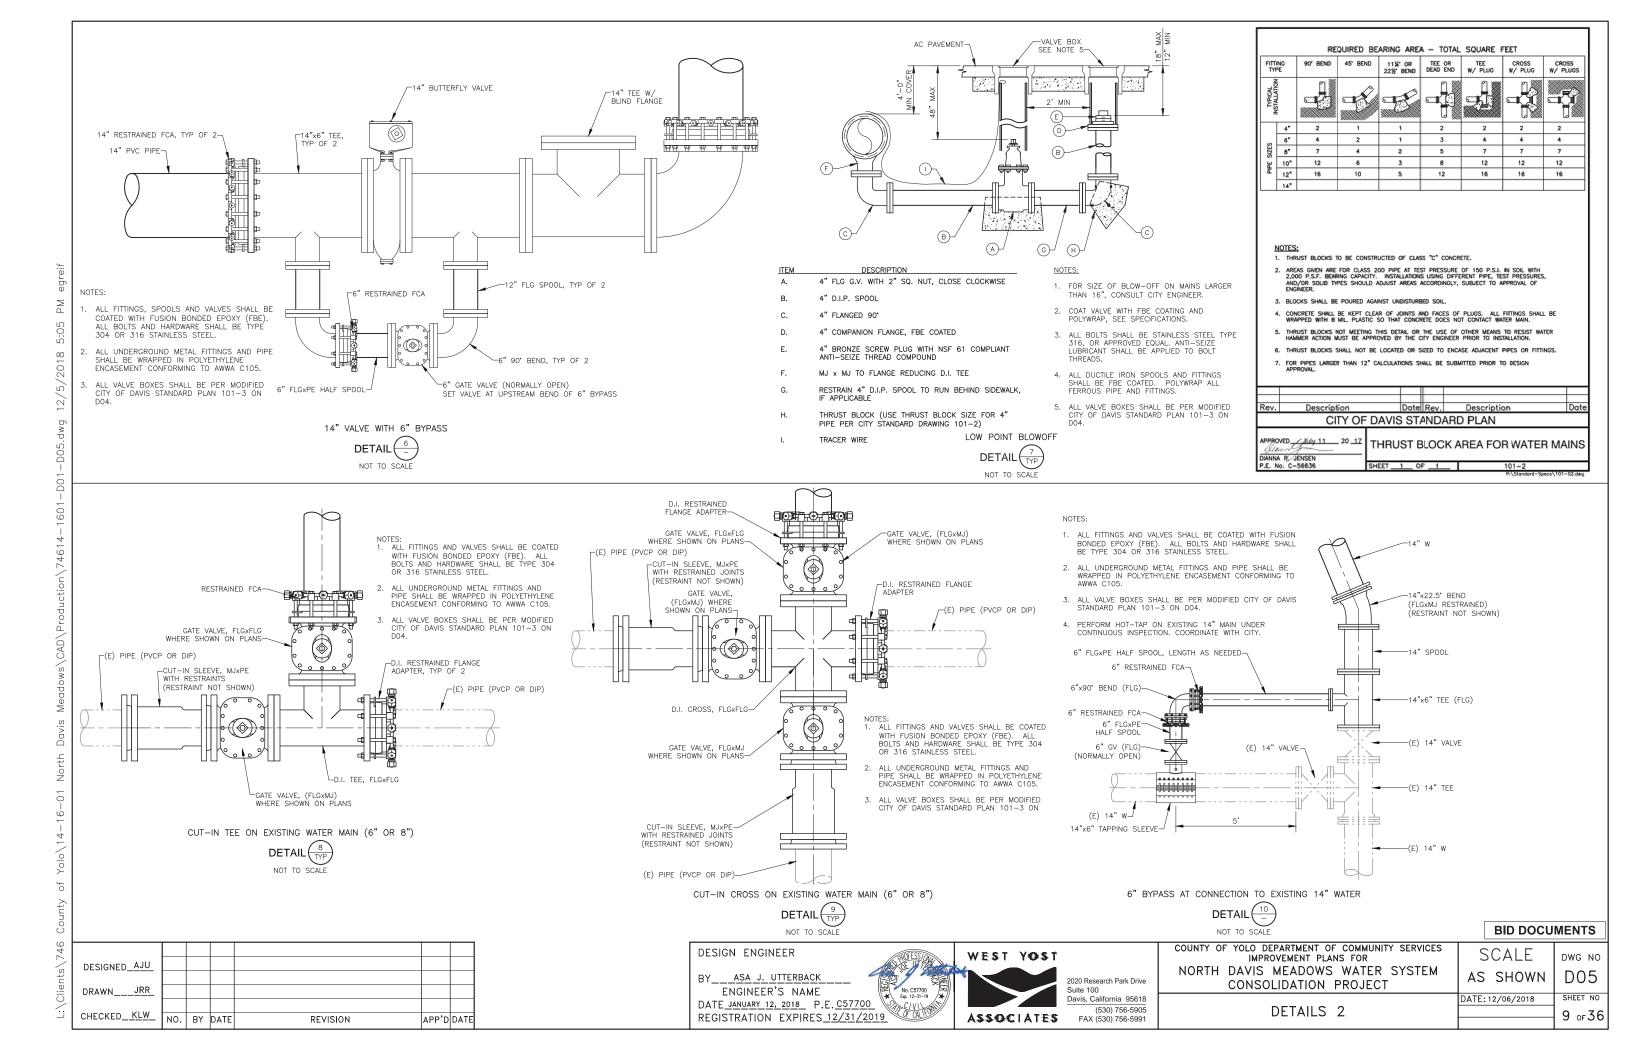

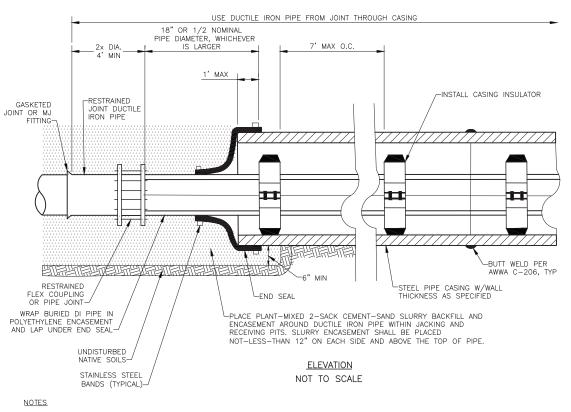

- 1. CONTRACTOR SHALL TAKE CARE TO PLACE SAND ANNULAR FILL BETWEEN THE CARRIER PIPE(S) AND THE CASING WITHOUT DAMAGING OR DISPLACING THE INSTALLED CARRIER PIPE OR CONDUITS.
- 2. CARRIER PIPE ELEVATIONS HAVE BEEN DESIGNED FOR CENTERED INSTALLATION OF THE CARRIER PIPE IN THE CASING.

 NON-CENTERRED INSTALLATION MAY BE ALLOWED UPON APPROVAL OF THE ENGINEER. IF APPROVED, CONTRACTOR SHALL BE
 RESPONSIBLE FOR ADJUSTING CARRIER PIPE DESIGN ELEVATIONS TO FIT THEIR NON-CENTERRED INSTALLATION.
- 3. INSULATORS/SPACERS SHALL BE INSTALLED SO THAT THE FIRST AND LAST SKIDS INSTALLED ARE LOCATED NO MORE THAN 12" FROM THE OPEN ENDS OF CASING.
- 4. CASING INSULATOR SPACING SHALL NOT EXCEED SPACING RECOMMENDED BY INSULATOR MANUFACTURER.
- 5. CONTRACTOR SHALL EXCAVATE JACKING AND RECEIVING PITS TO ALLOW CASING TO EXTEND AT LEAST 1' INTO PIT.
- 6. CONTRACTOR SHALL CONTINUOUSLY MONITOR BORE CUTTINGS FOR NON-COHESIVE SOIL CHARACTERISTICS AND EXTRACTION VOLUME RELATIVE TO BORE PRODUCTION. IF NON-COHESIVE SOILS OR OTHER UNFORESEEN CONDITIONS ARE ENCOUNTERED WHICH COULD DESTABILIZE THE OVERLYING SOILS, CONTRACTOR SHALL IMMEDIATELY STOP THE BORE AND NOTIFY THE ENGINEER.
- 7. CONTRACTOR SHALL SUBMIT A BORING PLAN FOR THE ENGINEER'S APPROVAL WHICH ACCOUNTS FOR THE SOIL CONDITIONS DESCRIBED IN THE GEOTECHNICAL SOIL REPORT PREPARED BY BLACKBURN CONSULTING FOR THIS WORK (COPY INCLUDED IN PROJECT SPECIFICATIONS).
- 8. FILL ALL VOIDS OUTSIDE THE CASING RESULTING FROM THE BORE WITH PRESSURE—INJECTED SAND—CEMENT GROUT. CASING SHALL BE SUPPLIED WITH MANUFACTURED PORTS FOR GROUT INJECTION. INJECTION PORTS SHALL BE SPACED AS NEEDED TO COMPLETELY FILL THE VOIDS CAUSED BY THE BORE, BUT IN NO CASE SPACED GREATER THAN 8 FEET ON—CENTER AT THE CROWN OF THE CASING. CONTRACTOR SHALL LOG THE QUANTITIES OF GROUT INJECTED.
- 9. CONTRACTOR SHALL ARRANGE PRE—JOB MEETING WITH THE STATE DOSH MINING AND TUNNELING UNIT AND CONFORM TO ALL REQUIREMENTS OF THE CALIFORNIA DEPARTMENT OF OCCUPATIONAL SAFETY AND HEALTH.

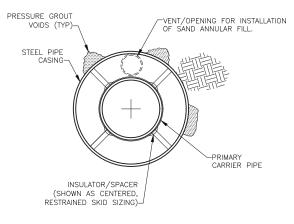

SECTION NOT TO SCALE

CASING/BORE	REQUIREMENT
CASING MATERIAL	ROLLED, WELDED STEEL IN ACCORDANCE WITH AWWA C200 AND WELDED PER AWWA C206. NO LINING OR COATING REQUIRED.
CASING DIAMETER	27" OD
CASING WALL THICKNESS	0.50" MIN
EXCAVATION CLASSIFICATION	NOT REQUIRED FOR BORE <30"
INSULATOR/SPACER	CALPICO M SERIES MODEL M-6-SS OR M-8-SS STAINLESS STEEL INSULATOR FOR 14" WATER PIPE. SIZE INSULATOR SKIDS FOR CENTERED RESTRAINED INSTALLATION OF CARRIER PIPE (14" DI WATER)
END SEAL	CALPICO MODEL "C" OR MODEL "W" END SEAL SECURED WITH STAINLESS STEEL STRAPS.
ANNULAR SPACE FILL	BLOWN SAND

CARRIER PIPES	PIPE TYPE	LOCATION: CR99D 301+53 TO 302+15
		SIZE/QUANTITY
CARRIER PIPE (POTABLE WATER)	RESTRAINED JOINT DUCTILE IRON PIPE PER AWWA C151 PRESSURE CLASS 250	14" DIAMETER / I EACH

BORE AND JACK DATA

BORE AND JACK PIPE INSTALLATION NO SCALE

BORE AND JACK PIPE INSTALLATION



DESIGNED_AJU						
DRAWNJRR_						
CHECKED_KLW_	NO.	BY	DATE	REVISION	APP'D	DATE
				*		

DESIGN ENGINEER

BY___ASA_J._UTTERBACK

ENGINEER'S NAME

DATE_JANUARY_12, 2018 P.E. C57700

REGISTRATION EXPIRES_12/31/2019




2020 Research Park Drive Suite 100 Davis, California 95618 (530) 756-5905 FAX (530) 756-5991 COUNTY OF YOLO DEPARTMENT OF COMMUNITY SERVICES IMPROVEMENT PLANS FOR
NORTH DAVIS MEADOWS WATER SYSTEM CONSOLIDATION PROJECT


DETAILS 3


SCALE DWG NO
AS SHOWN DO6


DATE: 12/06/2018 SHEET NO
10 of 36


COUNTY OF YOLO DEPARTMENT OF COMMUNITY SERVICES COALE

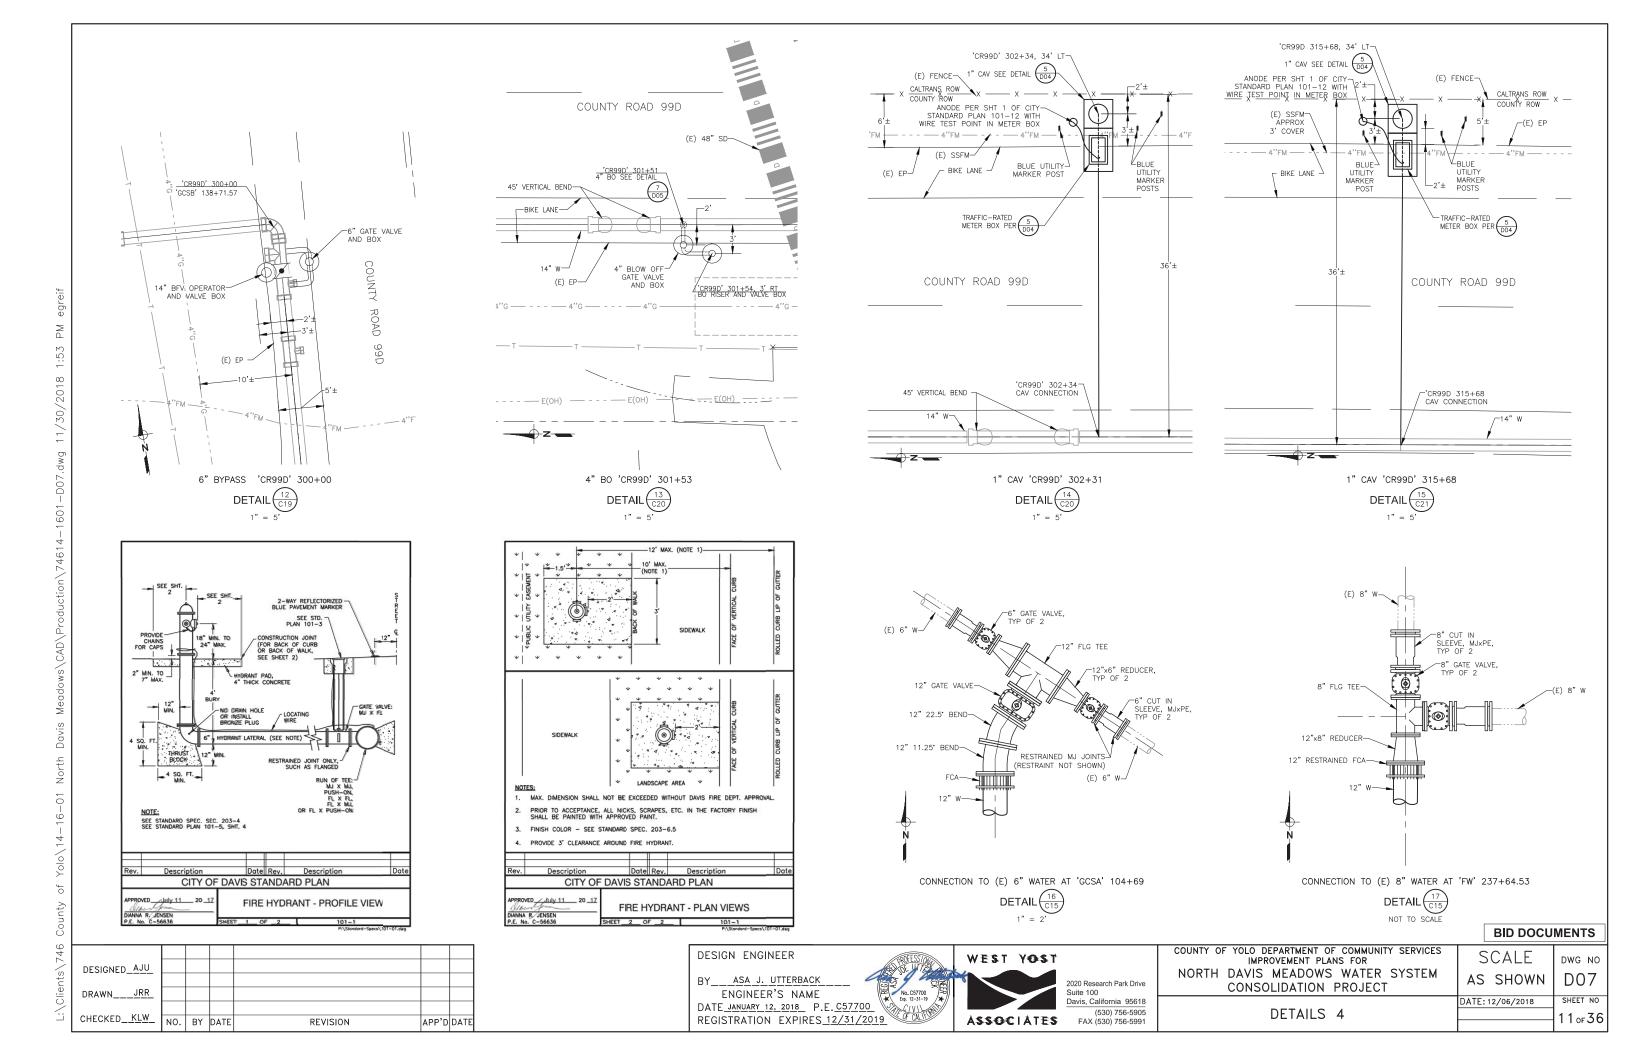


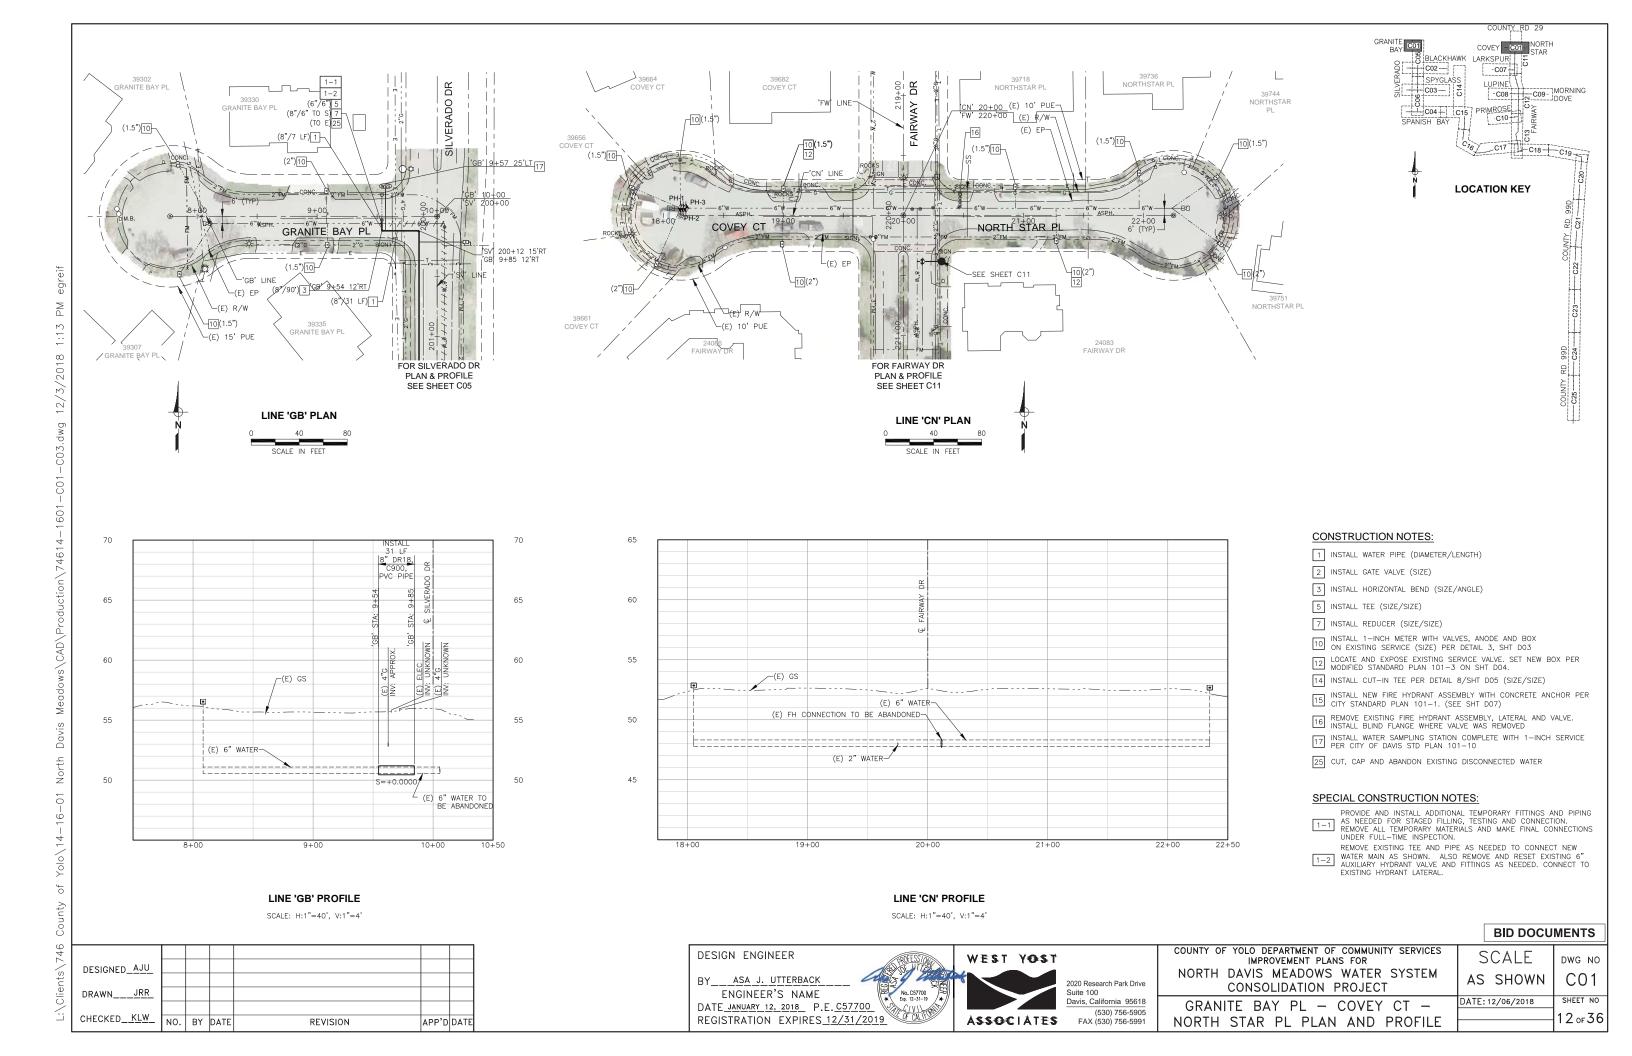


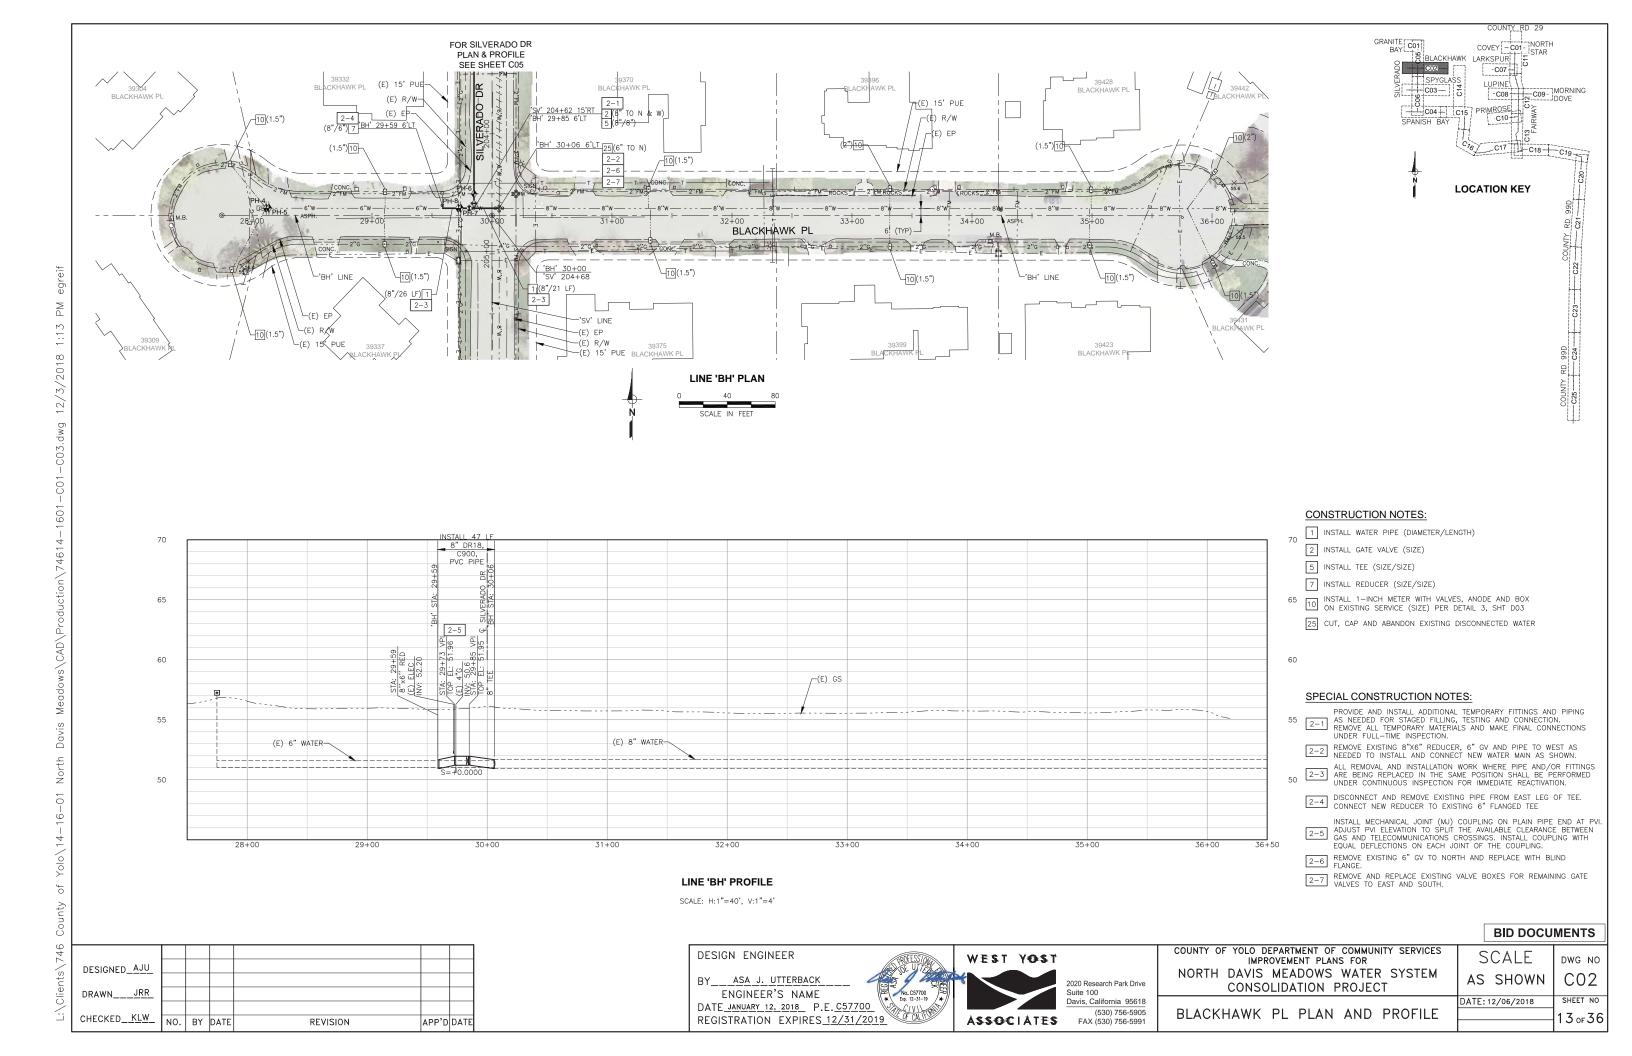


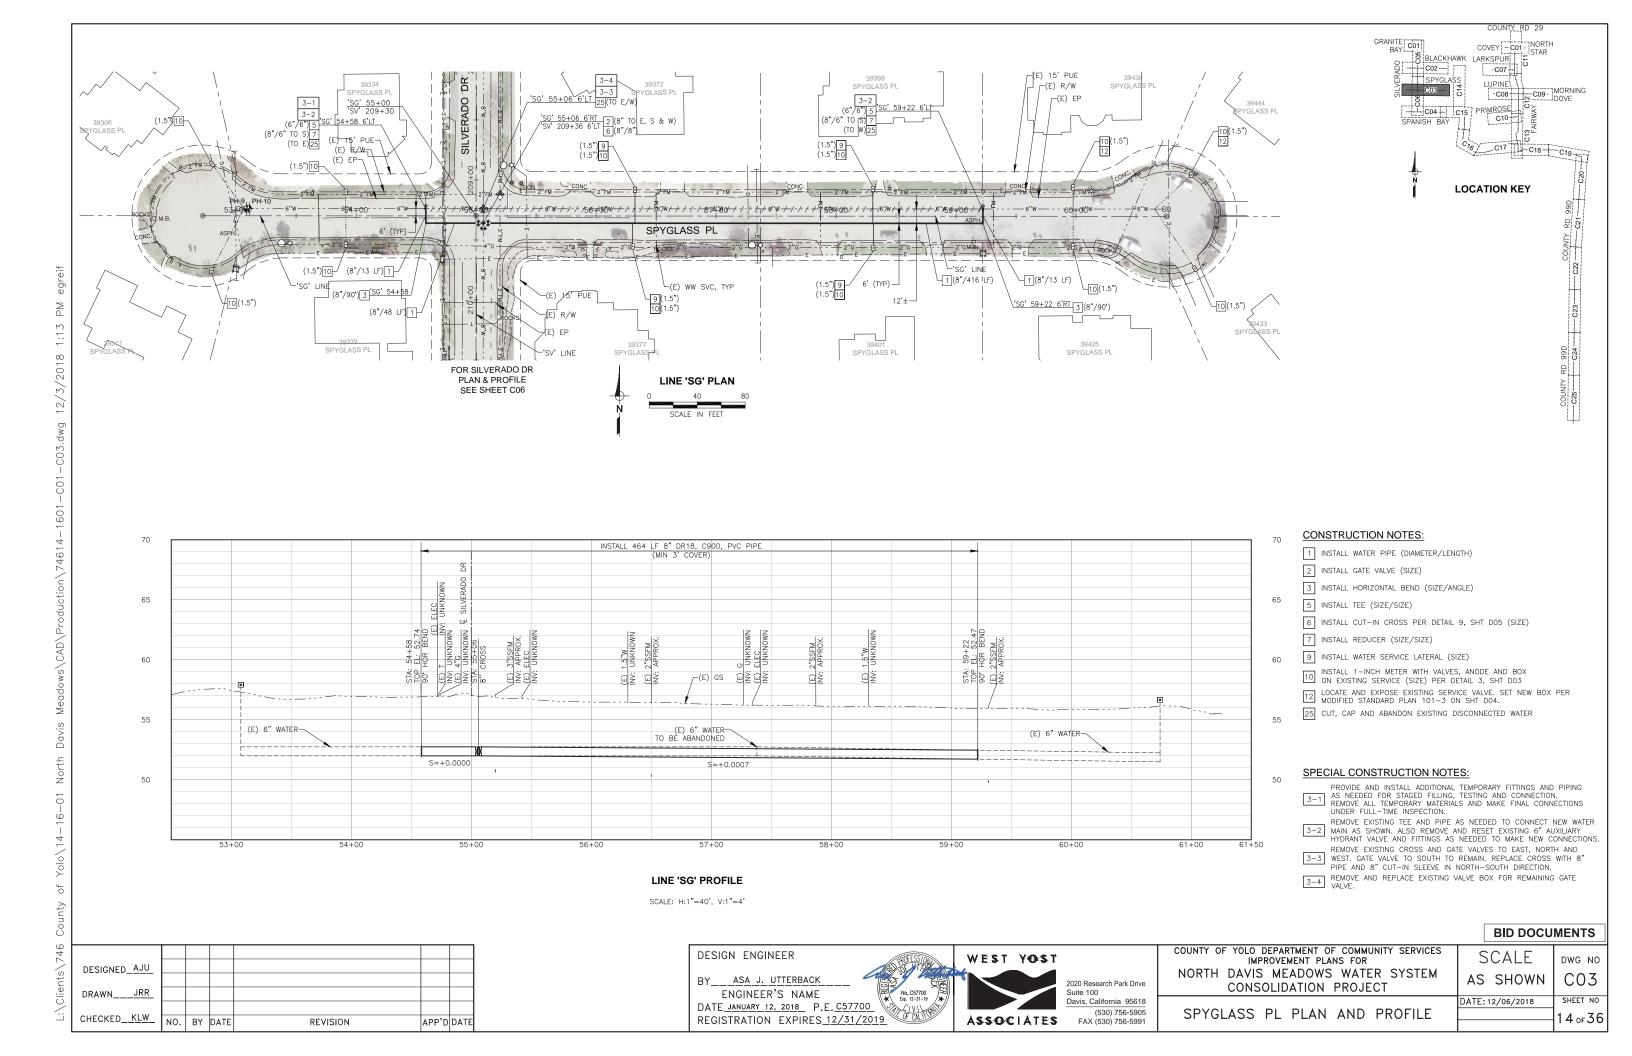

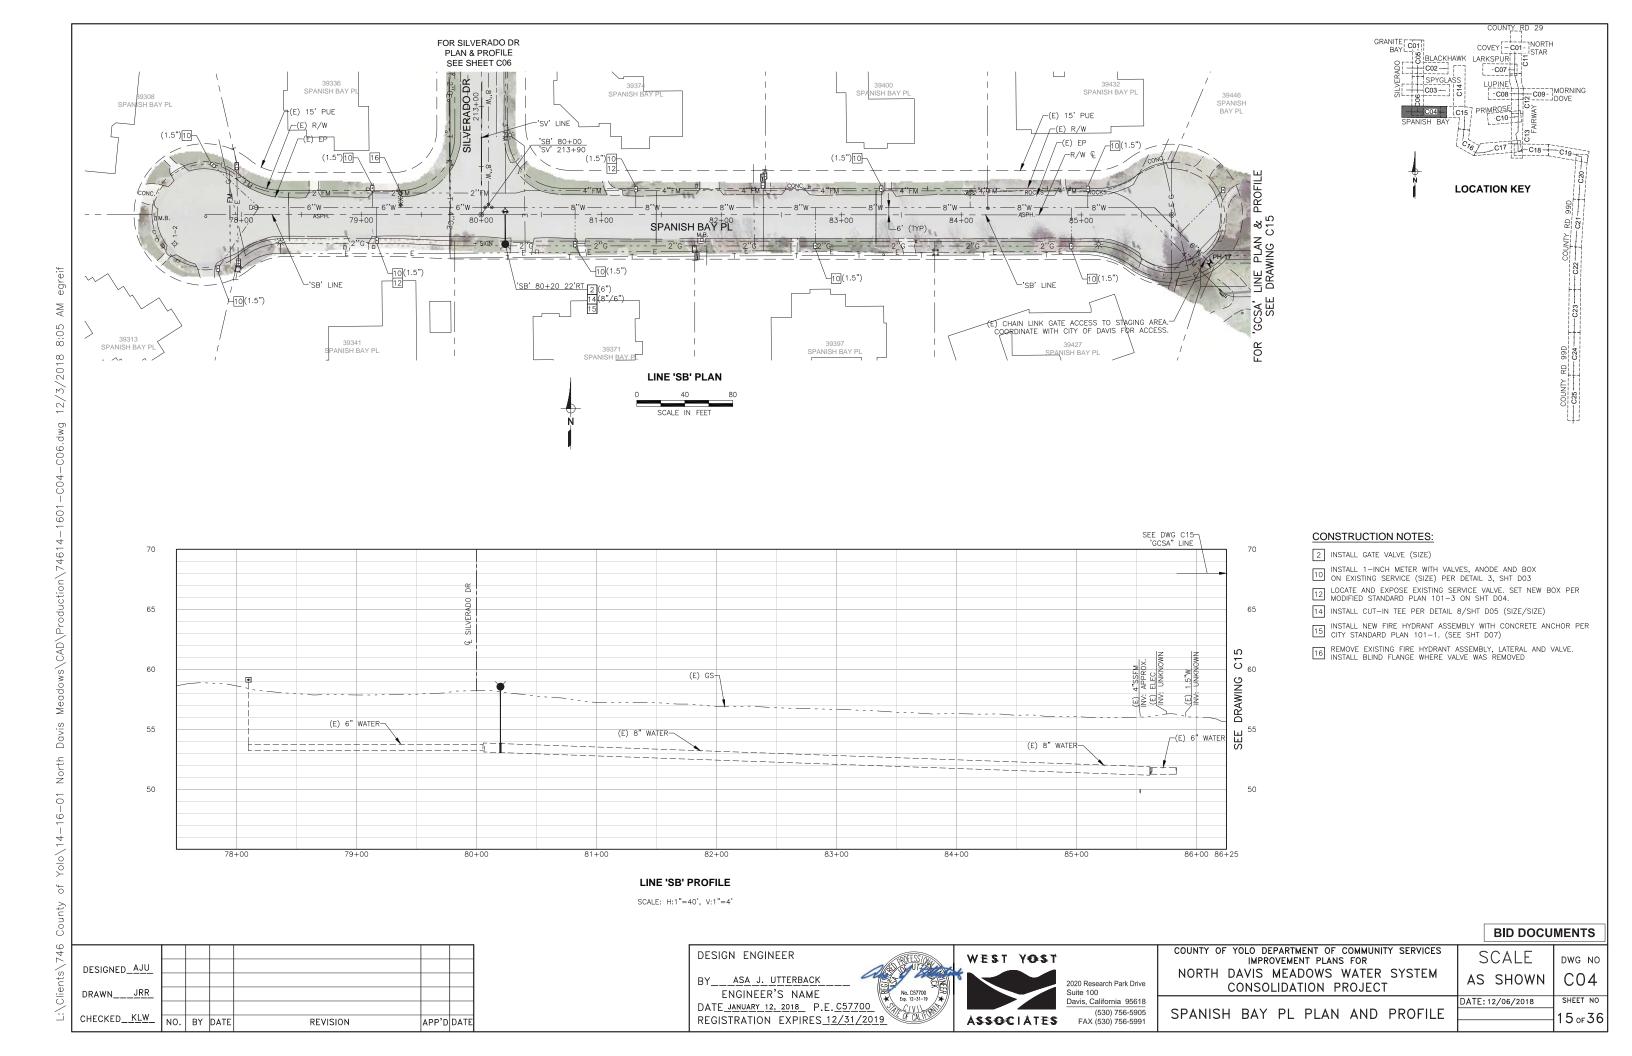

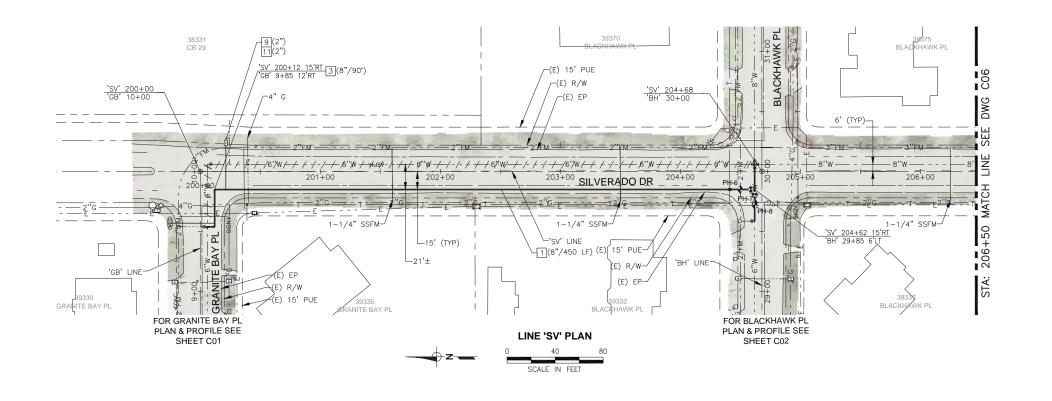

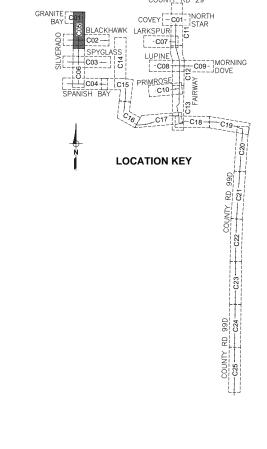

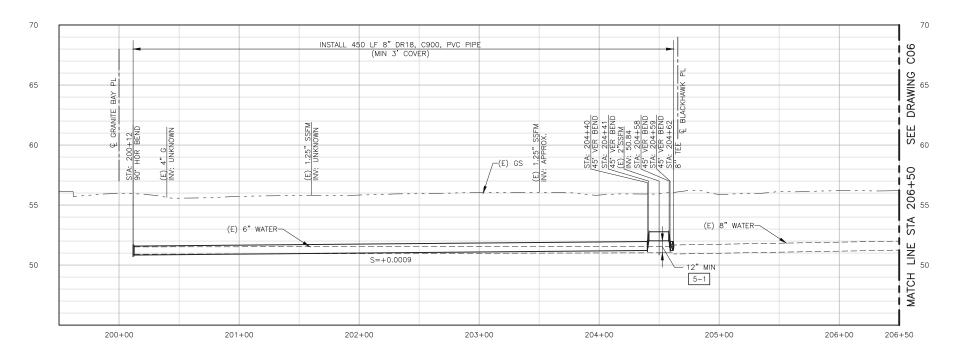

- 1 INSTALL WATER PIPE (DIAMETER/LENGTH)
- 3 INSTALL HORIZONTAL BEND (SIZE/ANGLE)
- 9 INSTALL WATER SERVICE LATERAL (SIZE)
- INSTALL METER WITH VALVES, ANODE AND BOX PER DETAIL 4, SHT DO3 AND CONNECT TO EXISTING IRRIGATION SERVICE. LOCATE EXISTING PIPE AT EXISTING BACKFLOW PREVENTER AND INSTALL METER ON SUPPLY SIDE OF BACKFLOW (SIZE)

SPECIAL CONSTRUCTION NOTES:

MAINTAIN A MINIMUM OF 12" CLEARANCE OVER SSFM CROSSING. INSTALL FULL STICK OF PIPE OVER (E) SSFM SO NO JOINTS ARE WITHIN 8 FEET CLEAR OF SSFM.

LINE 'SV' PROFILE

SCALE: H:1"=40', V:1"=4'

DESIGNED_AJU						
DRAWNJRR_						
CHECKED_KLW_	NO.	BY	DATE	REVISION	APP'D	DATE

 $\stackrel{\forall}{\mathbb{A}}$

 ${\tt Meadows} \\ {\tt CAD} \\ {\tt Production} \\ \\ {\tt 74614-1601-C04-C06.dwg} \\ 12/3/2018 \\ 8:05 \\$

North Davis

L:\Clients\746 County of Yolo\14-16-01

DESIGN ENGINEER

BY___ASA_J. UTTERBACK

ENGINEER'S NAME

DATE_JANUARY 12, 2018 P.E. C57700

REGISTRATION EXPIRES 12/31/2019





2020 Research Park Drive Suite 100 Davis, California 95618 (530) 756-5905 FAX (530) 756-5991 COUNTY OF YOLO DEPARTMENT OF COMMUNITY SERVICES
IMPROVEMENT PLANS FOR
NORTH DAVIS MEADOWS WATER SYSTEM
CONSOLIDATION PROJECT

SILVERADO DR PLAN AND PROFILE 1

SCALE DWG NO
AS SHOWN CO5

DATE: 12/06/2018 SHEET NO
16 of 36

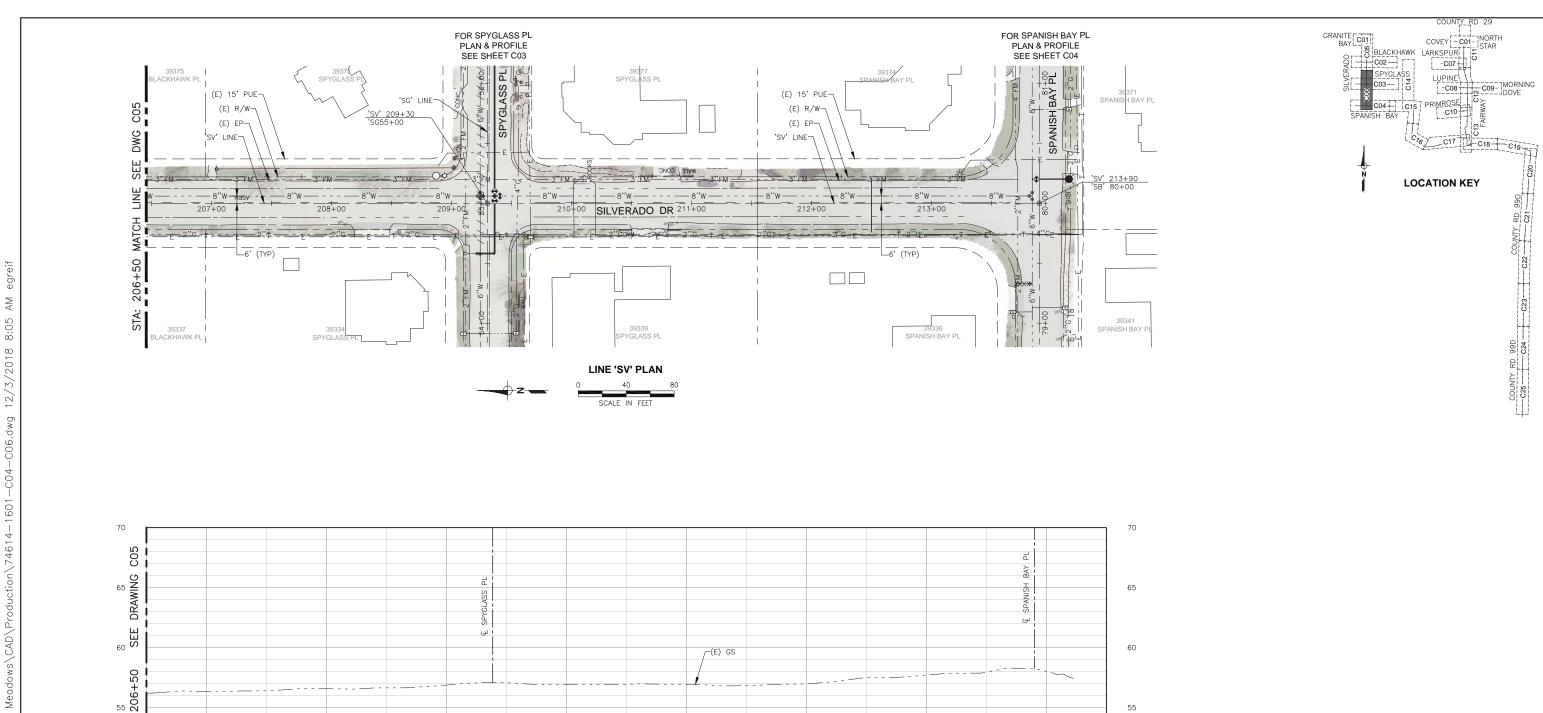

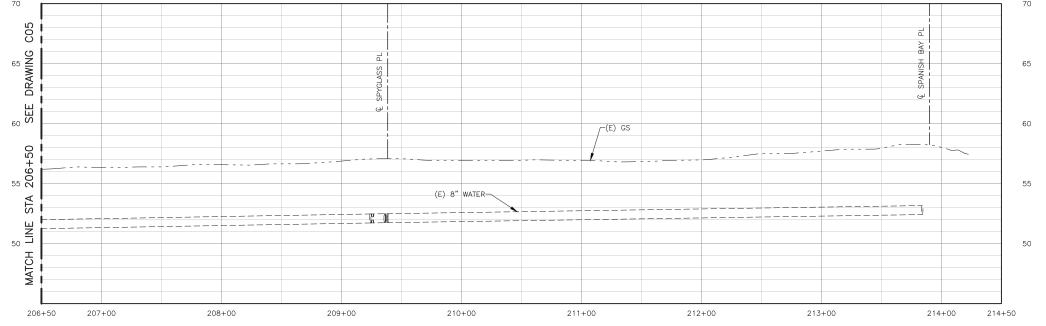

SPECIAL CONSTRUCTION NOTES:

6-1 THIS SHEET IS FOR INFORMATION ONLY. NO CONSTRUCTION REQUIREMENTS ARE SHOWN ON THIS SHEET.

17 of 36

LINE 'SV' PROFILE

SCALE: H:1"=40', V:1"=4'

DESIGNED_AJU						
DRAWNJRR_						
CHECKED_KLW_	NO.	BY	DATE	REVISION	APP'D	DATE


L:\Clients\746 County of Yolo\14-16-01 North Davis


DESIGN ENGINEER	Γ,
BYASA_JUTTERBACK	*
REGISTRATION EXPIRES 12/31/2019	



2020 Research Park Drive Suite 100 Davis, California 95618 (530) 756-5905 FAX (530) 756-5991

	BID DOCU	MENTS
COUNTY OF YOLO DEPARTMENT OF COMMUNITY SERVICES IMPROVEMENT PLANS FOR NORTH DAVIS MEADOWS WATER SYSTEM CONSOLIDATION PROJECT	SCALE AS SHOWN	DWG NO
SILVERADO DR PLAN AND PROFILE 2	DATE: 12/06/2018	SHEET NO 17 of 36

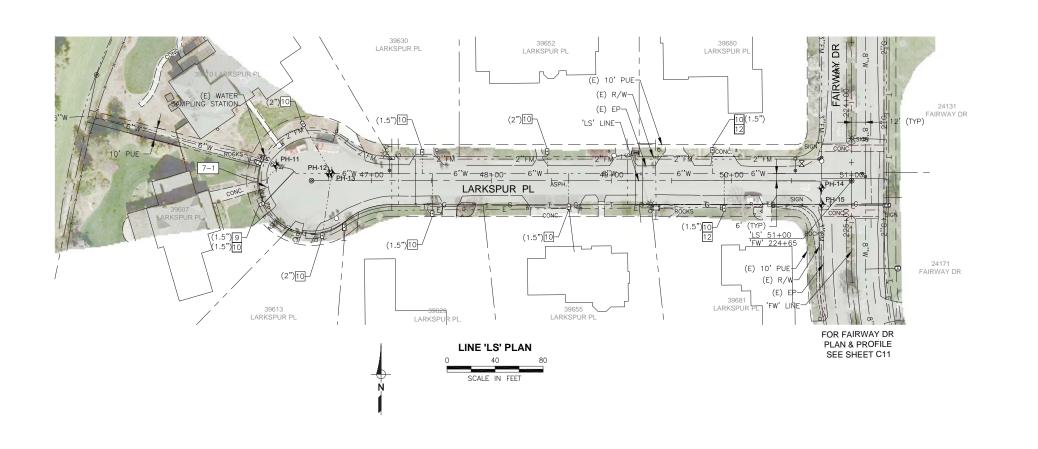

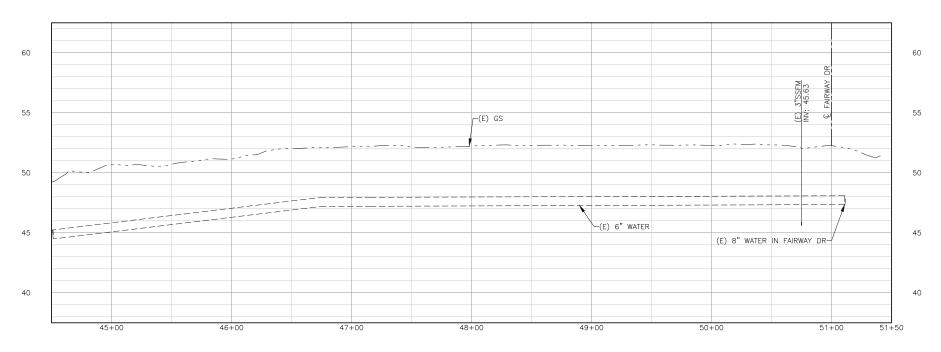

SPECIAL CONSTRUCTION NOTES:

CONSTRUCTION NOTES:

9 INSTALL WATER SERVICE LATERAL (SIZE)

INSTALL 1-INCH METER WITH VALVES, ANODE AND BOX ON EXISTING SERVICE (SIZE) PER DETAIL 3, SHT DO3

LOCATE AND EXPOSE EXISTING SERVICE VALVE. SET NEW BOX PER MODIFIED STANDARD PLAN 101-3 ON SHT D04.

[7-1] A PORTION OF THE EXISTING WATER SERVICE PIPE FOLLOWS AND LAYS PARTIALLY UNDERNEATH EXISTING MAIN. LOCATE, DISCONNECT, CAP AND ABANDON EXISTING SERVICE CONNECTION.

LINE 'LS' PROFILE

SCALE: H:1"=40', V:1"=4'

•						
DESIGNED_AJU						
DRAWNJRR_						
CHECKED <u>KLW</u>	NO.	BY	DATE	REVISION	APP'D	DATE

L:\Clients\746 County of Yolo\14-16-01 North Davis Meadows\CAD\Production\74614-1601-C07-C09.dwg 12/3/2018 8:19 AM

DESIGN ENGINEER

BY___ASA_J._UTTERBACK

ENGINEER'S NAME

DATE JANUARY 12, 2018 P.E. C57700

REGISTRATION EXPIRES 12/31/2019



2020 Research Park Drive Suite 100 Davis, California 95618 (530) 756-5905 FAX (530) 756-5991

COUNTY OF YOLO DEPARTMENT OF COMMUNITY SERVICES
IMPROVEMENT PLANS FOR
NORTH DAVIS MEADOWS WATER SYSTEM
CONSOLIDATION PROJECT

LARKSPUR PL PLAN AND PROFILE

BID DOCU	MENTS
SCALE	DWG NO
AS SHOWN	C07
DATE: 12/06/2018	SHEET NO
	18 of 36


COVEY [-C01-]NORTH

LOCATION KEY

C09- MORNING DOVE

BLACKHAWK LARKSPUR

C03 - 5

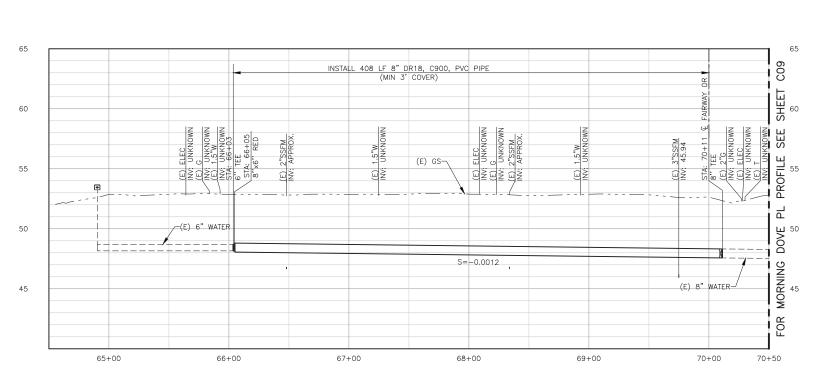

LINE 'LM' PROFILE

SCALE: H:1"=40', V:1"=4'

CONSTRUCTION NOTES:

- 1 INSTALL WATER PIPE (DIAMETER/LENGTH)
- 2 INSTALL GATE VALVE (SIZE)
- 5 INSTALL TEE (SIZE/SIZE)
- 7 INSTALL REDUCER (SIZE/SIZE)
- 9 INSTALL WATER SERVICE LATERAL (SIZE)
- INSTALL 1-INCH METER WITH VALVES, ANODE AND BOX ON EXISTING SERVICE (SIZE) PER DETAIL 3, SHT DO3
- 12 LOCATE AND EXPOSE EXISTING SERVICE VALVE. SET NEW BOX PER MODIFIED STANDARD PLAN 101-3 ON SHT DO4.

RIMROSE C10

LOCATION KEY

C08 C09- MORNING

C17 C18 C19

C25 C24 C23 C22 C0UNTY RD 99D

C03- 5

SPANISH BAY

GRANITE C01

- 14 INSTALL CUT-IN TEE PER DETAIL 8, SHT D05 (SIZE/SIZE)
- 25 CUT, CAP AND ABANDON EXISTING DISCONNECTED WATER

SPECIAL CONSTRUCTION NOTES:

- PROVIDE AND INSTALL ADDITIONAL TEMPORARY FITTINGS AND PIPING AS NEEDED FOR STAGED FILLING, TESTING AND CONNECTION. REMOVE ALL TEMPORARY MATERIALS AND MAKE FINAL CONNECTIONS
- UNDER FULL-TIME INSPECTION. $\fbox{8-2}$ DISCONNECT AND REMOVE EXISTING PIPE FROM EAST LEG OF TEE AND INSTALL BLIND FLANGE ON TEE.
- $\fbox{8-3}$ REMOVE EXISTING GATE VALVE TO WEST AND REPLACE WITH BLIND FLANGE.
- 8-4 REMOVE AND REPLACE EXISTING VALVE BOXES FOR REMAINING GATE VALVES.
- 8-5 CONNECT EXISTING 6" FIRE HYDRANT LATERAL TO NORTH.

DESIGNED_AJU						
DRAWNJRR_						
CHECKED KLW	NO.	BY	DATE	REVISION	APP'D	DATE

8:19 AM

 ${\tt Meadows} \\ {\tt CAD} \\ {\tt Production} \\ \\ {\tt 74614-1601-C07-C09.dwg} \\ 12/3/2018 \\$

North Davis

of Yolo\14-16-01

County

L:\Clients\746

DESIGN ENGINEER

ASA J. UTTERBACK ENGINEER'S NAME DATE JANUARY 12, 2018 P.E. C57700 REGISTRATION EXPIRES 12/31/2019



FOR FAIRWAY DR


2020 Research Park Drive Suite 100 Davis, California 95618 (530) 756-5905 FAX (530) 756-5991 COUNTY OF YOLO DEPARTMENT OF COMMUNITY SERVICES IMPROVEMENT PLANS FOR NORTH DAVIS MEADOWS WATER SYSTEM CONSOLIDATION PROJECT

AS SHOWN DATE: 12/06/2018

LUPINE COURT PLAN AND PROFILE

SCALE DWG NO C08 SHEET NO 19 оғ 36

BID DOCUMENTS

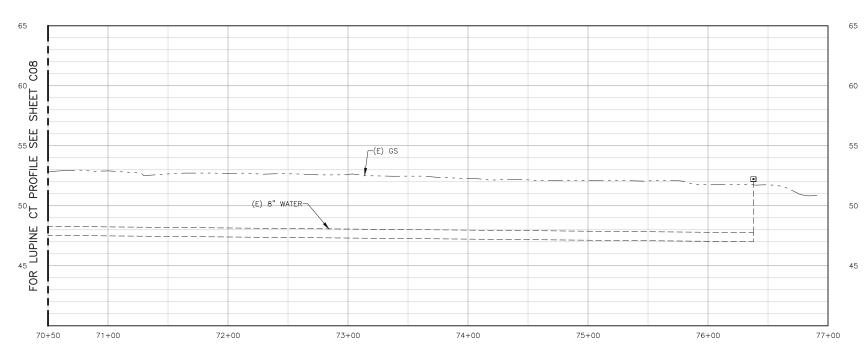

- INSTALL 1-INCH METER WITH VALVES, ANODE AND BOX ON EXISTING SERVICE (SIZE) PER DETAIL 3, SHT DO3

 LOCATE AND EXPOSE EXISTING SERVICE VALVE. SET NEW BOX PER MODIFIED STANDARD PLAN 101-3 ON SHT DO4.

20 оғ 36

COVEY CO1

LOCATION KEY

LINE 'LM' PROFILE

SCALE: H:1"=40', V:1"=4'

DESIGNED_AJU DRAWN_ CHECKED_KLW_

REVISION

APP'D DATE

NO. BY DATE

County of Yolo\14-16-01 North Davis Meadows\CAD\Production\74614-1601-C07-C09.dwg 12/3/2018 8:19 AM


L:\Clients\746

DESIGN ENGINEER BY___ASA_J._UTTERBACK ENGINEER'S NAME DATE JANUARY 12, 2018 P.E. C57700 REGISTRATION EXPIRES 12/31/2019



2020 Research Park Drive Suite 100 Davis, California 95618 (530) 756-5905 FAX (530) 756-5991

	BID DOCU	MENTS
COUNTY OF YOLO DEPARTMENT OF COMMUNITY SERVICES IMPROVEMENT PLANS FOR	SCALE	DWG NO
NORTH DAVIS MEADOWS WATER SYSTEM CONSOLIDATION PROJECT	AS SHOWN	C09
	DATE: 12/06/2018	SHEET NO
MORNING DOVE PL PLAN AND PROFILE		20 of 36

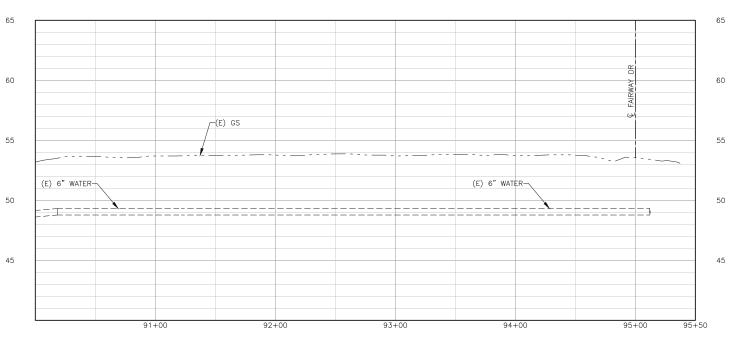

- INSTALL 1-INCH METER WITH VALVES, ANODE AND BOX ON EXISTING SERVICE (SIZE) PER DETAIL 3, SHT DO3
- 12 LOCATE AND EXPOSE EXISTING SERVICE VALVE. SET NEW BOX PER MODIFIED STANDARD PLAN 101-3 ON SHT D04.

COVEY COT NORTH

LOCATION KEY

LINE 'PR' PROFILE

SCALE: H:1"=40', V:1"=4'

DESIGNED_AJU

DRAWN___JRR

CHECKED_KLW__NO. BY DATE REVISION APP'D DATE

County of Yolo\14-16-01 North Davis Meadows\CAD\Production\74614-1601-C10.dwg 12/3/2018 8:37 AM $^{\circ}$

L:\Clients\746

DESIGN ENGINEER




2020 Research Park Drive Suite 100 Davis, California 95618 (530) 756-5905 FAX (530) 756-5991


COUNTY OF YOLO DEPARTMENT OF COMMUNITY SERVICES	T
IMPROVEMENT PLANS FOR	ı
NORTH DAVIS MEADOWS WATER SYSTEM	ı
CONSOLIDATION PROJECT	
	Т


PRIMROSE PL PLAN AND PROFILE

SCALE DWG NO
AS SHOWN C10

DATE: 12/06/2018 SHEET NO
21 of 36

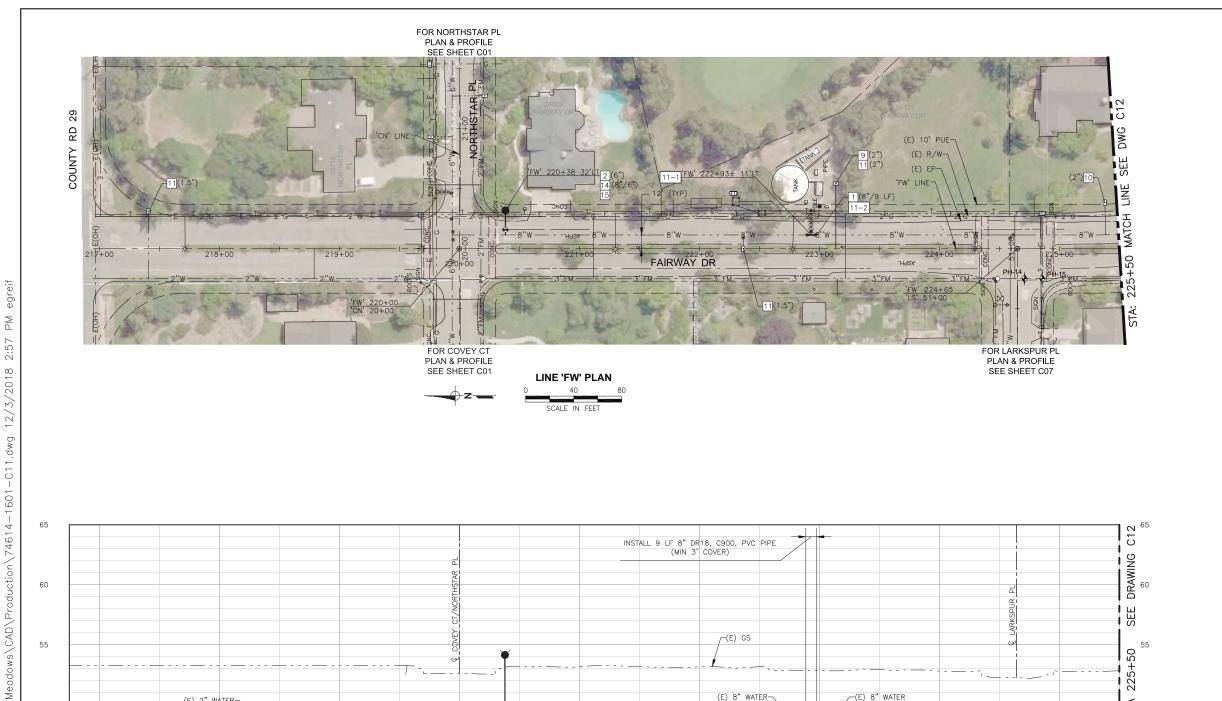

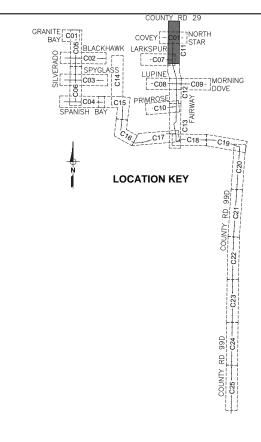

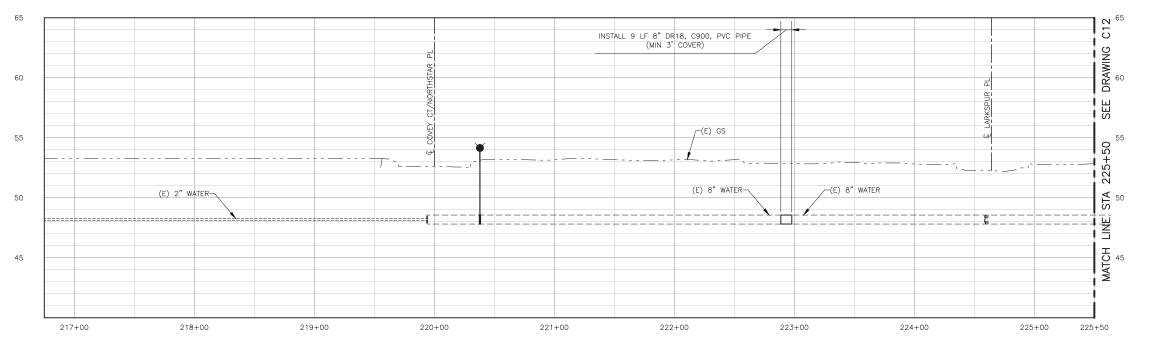

- 1 INSTALL WATER PIPE (DIAMETER/LENGTH)
- 9 INSTALL WATER SERVICE LATERAL (SIZE)
- INSTALL 1-INCH METER WITH VALVES, ANODE AND BOX ON EXISTING SERVICE (SIZE) PER DETAIL 3, SHT DO3
- INSTALL METER WITH VALVES, ANODE AND BOX PER DETAIL 4, SHT DO3

 AND CONNECT TO EXISTING IRRIGATION SERVICE. LOCATE EXISTING PIPE
 AT EXISTING BACKFLOW PREVENTER AND INSTALL METER ON SUPPLY SIDE OF BACKFLOW (SIZE)
- 14 INSTALL CUT-IN TEE PER DETAIL 8, SHT D05 (SIZE/SIZE)
- 15 INSTALL NEW FIRE HYDRANT ASSEMBLY WITH CONCRETE ANCHOR PER CITY STANDARD PLAN 101-1. (SEE SHT D07)

SPECIAL CONSTRUCTION NOTES:

REMOVE EXISTING TEE AND CLUSTER OF 3 VALVES AT 8" MAIN AND

- 25 LF OF 8" PIPE TO EAST. CAP AND ABANDON EXISTING PIPE FROM WELL. THIS WORK SHALL NOT BE PERFORMED UNTIL ALL OTHER PIPE CONSTRUCTION IS COMPLETED, TESTED, FLUSHED, AND READY TO BE PUT INTO SERVICE. COORDINATE WELL DISCONNECTION WITH REMOVAL OF BACKFLOW PREVENTION AT CONNECTION TO CITY SYSTEM PER NOTE 25–3 ON SHEET C25.
 - INSTALL NEW PIPE IN PLACE OF REMOVED VALVES, FITTINGS AND PIPE ON EXISTING 8" WATER MAIN IN FAIRWAY DRIVE. CONNECT WITH ONE CUT-IN SLEEVE AND A BELL AND SPIGOT JOINT. INSTALL UNDER CONTINUOUS INSPECTION.

LINE 'FW' PROFILE

SCALE: H:1"=40', V:1"=4'

DESIGNED_AJU						
DRAWNJRR_						
CHECKED KLW	NO.	BY	DATE	REVISION	APP'D	DATE

Davis

North

of Yolo\14-16-01

County

L:\Clients\746

DESIGN ENGINEER

ASA J. UTTERBACK ENGINEER'S NAME DATE JANUARY 12, 2018 P.E. C57700 REGISTRATION EXPIRES 12/31/2019





2020 Research Park Drive Suite 100 Davis, California 95618 (530) 756-5905 FAX (530) 756-5991 COUNTY OF YOLO DEPARTMENT OF COMMUNITY SERVICES IMPROVEMENT PLANS FOR NORTH DAVIS MEADOWS WATER SYSTEM CONSOLIDATION PROJECT

BID DOCUMENTS SCALE DWG NO AS SHOWN C11 DATE: 12/06/2018

FAIRWAY DR PLAN AND PROFILE 1

SHEET NO 22 оғ 36

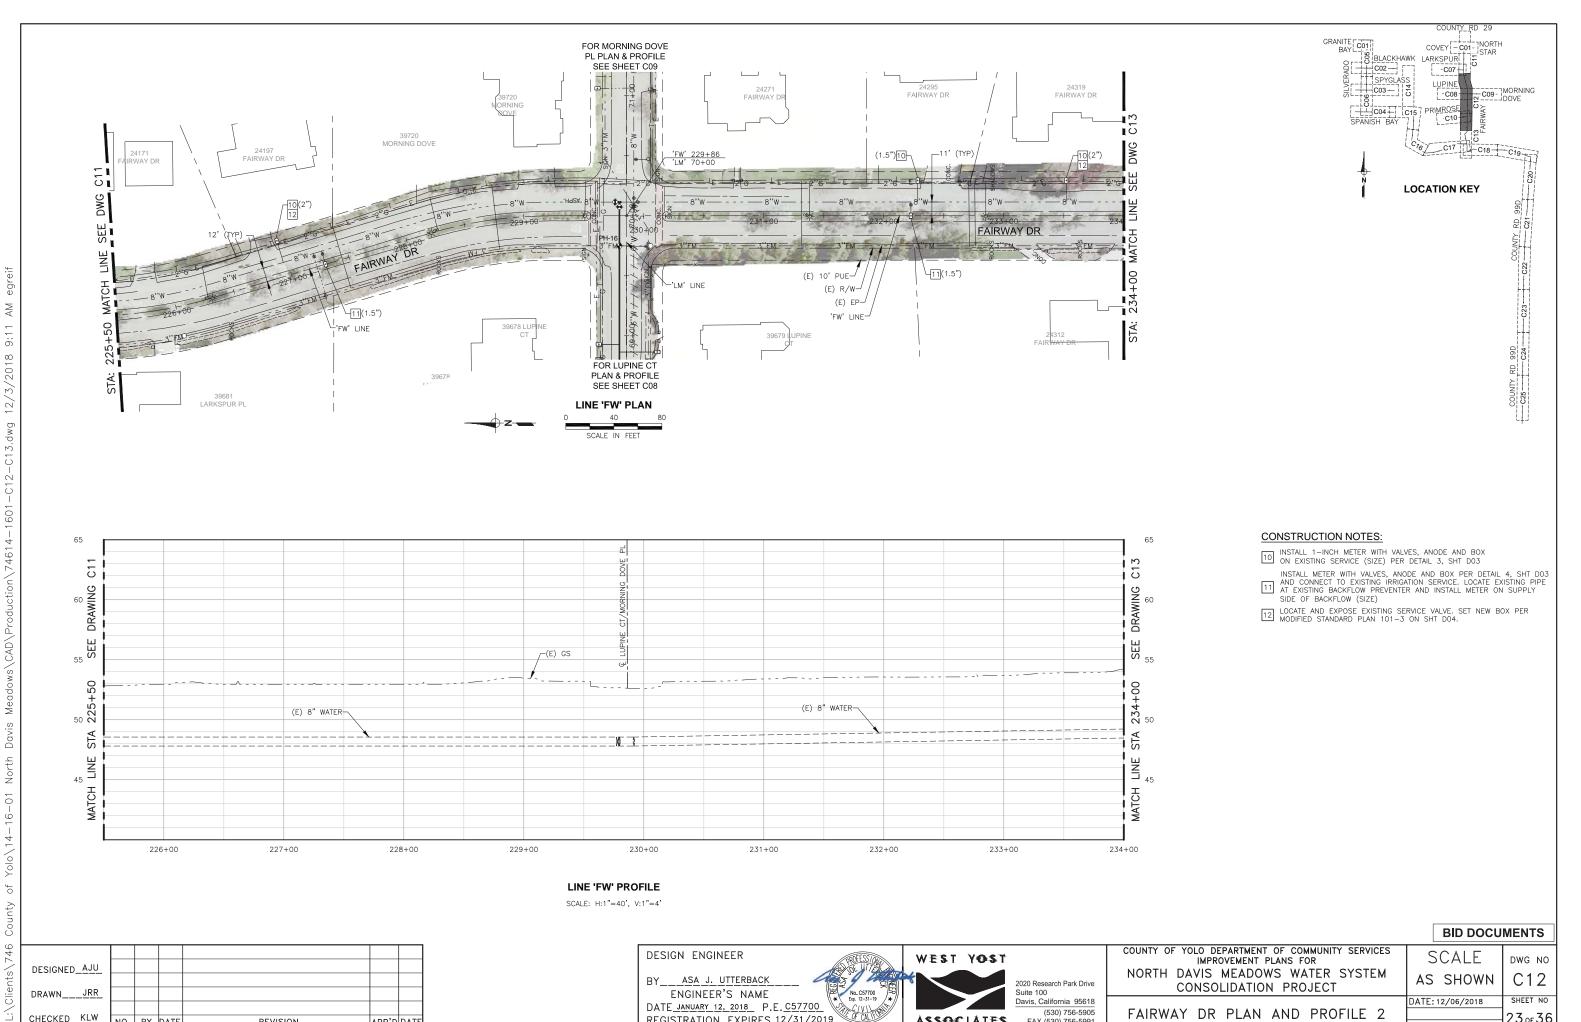

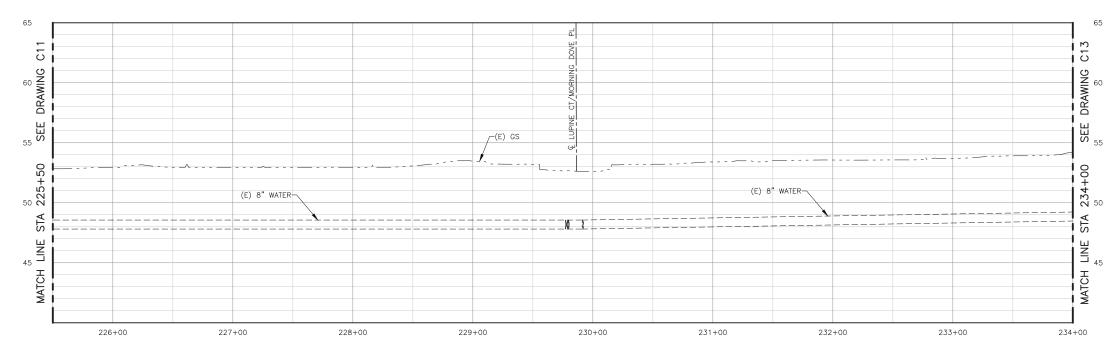

- INSTALL 1-INCH METER WITH VALVES, ANODE AND BOX ON EXISTING SERVICE (SIZE) PER DETAIL 3, SHT DO3
- INSTALL METER WITH VALVES, ANODE AND BOX PER DETAIL 4, SHT DO3 AND CONNECT TO EXISTING IRRIGATION SERVICE. LOCATE EXISTING PIPE AT EXISTING BACKFLOW PEVENTER AND INSTALL METER ON SUPPLY SIDE OF BACKFLOW (SIZE)
- 12 LOCATE AND EXPOSE EXISTING SERVICE VALVE. SET NEW BOX PER MODIFIED STANDARD PLAN 101-3 ON SHT DO4.

LINE 'FW' PROFILE

SCALE: H:1"=40', V:1"=4'

•						
DESIGNED_AJU						
DRAWNJRR_						
CHECKED <u>KLW</u>	NO.	BY	DATE	REVISION	APP'D	DATE


DESIGN ENGINEER BY___ASA_J._UTTERBACK ENGINEER'S NAME DATE JANUARY 12, 2018 P.E. C57700 REGISTRATION EXPIRES 12/31/2019



2020 Research Park Drive Suite 100 Davis, California 95618 (530) 756-5905 FAX (530) 756-5991

	COUNTY OF YOLO DEPARTMENT
PLANS FOR	IMPROVEMENT
DWS WATER SYSTEM	NORTH DAVIS MEADO
ON PROJECT	CONSOLIDATIO
I AND PROFILE 2 F	FAIRWAY DR PLAN
AND INOFILE Z	TAINWAT DR FLAN

BID DOCUMENTS SCALE DWG NO C12 AS SHOWN DATE: 12/06/2018 SHEET NO 23 оғ 36

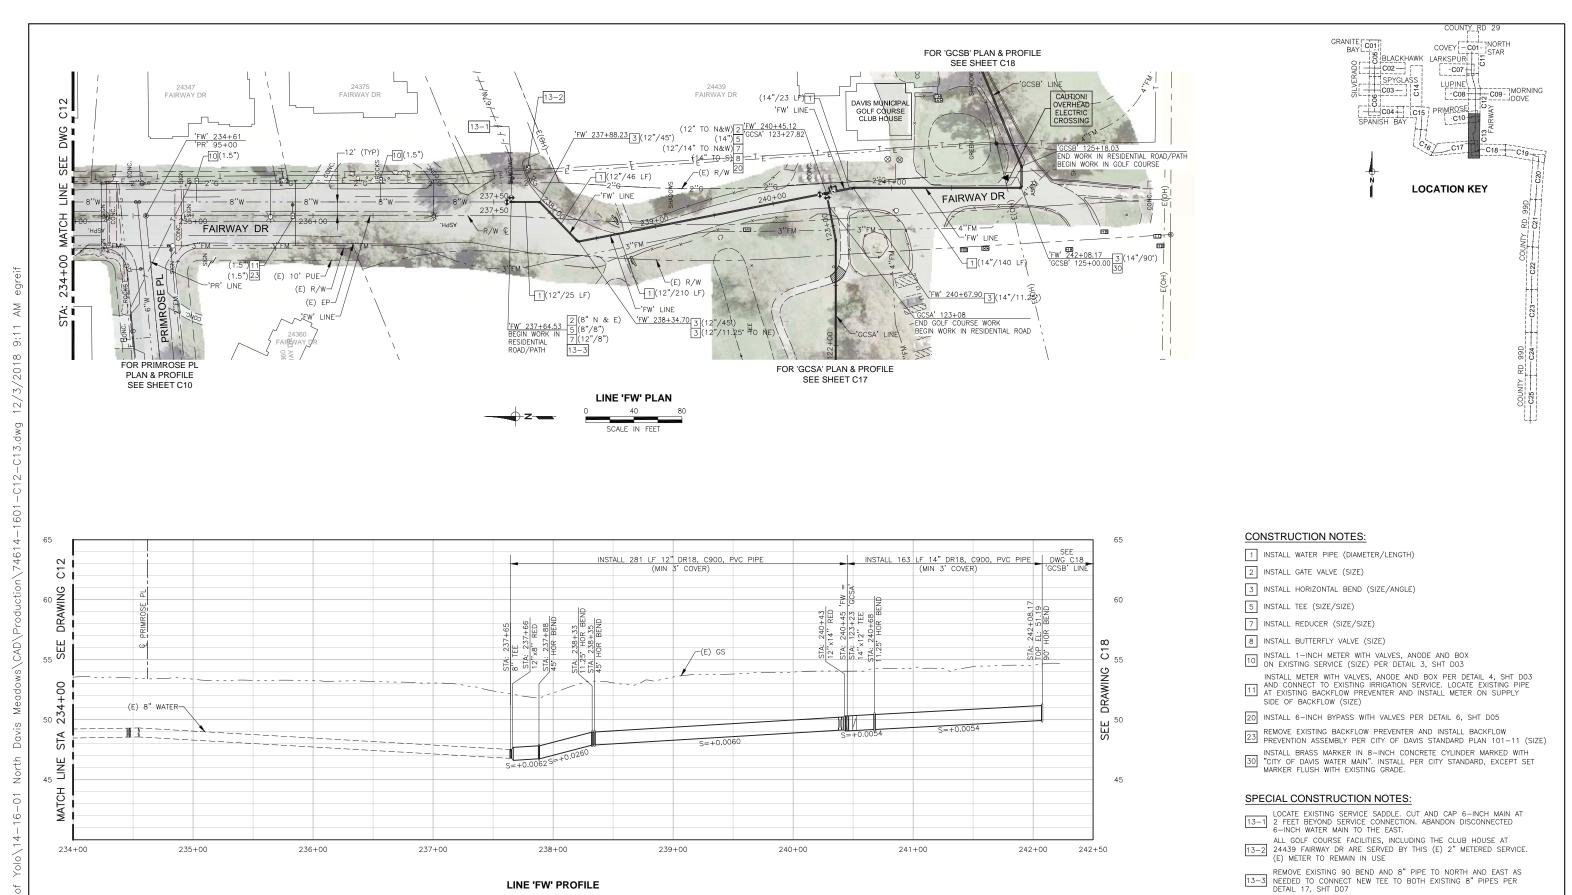

LINE 'FW' PROFILE

SCALE: H:1"=40', V:1"=4'

DESIGNED_AJU DRAWN CHECKED KLW NO. BY DATE REVISION APP'D DATE

of

L:\Clients\746

DESIGN ENGINEER ASA J. UTTERBACK ENGINEER'S NAME DATE JANUARY 12, 2018 P.E. C57700 REGISTRATION EXPIRES 12/31/2019



2020 Research Park Drive Suite 100 Davis, California 95618 (530) 756-5905 FAX (530) 756-5991


COUNTY OF YOLO DEPARTMENT OF COMMUNITY SERVICES IMPROVEMENT PLANS FOR NORTH DAVIS MEADOWS WATER SYSTEM CONSOLIDATION PROJECT

AS SHOWN DATE: 12/06/2018

FAIRWAY DR PLAN AND PROFILE 3

DWG NO C13 SHEET NO 24 of 36

BID DOCUMENTS

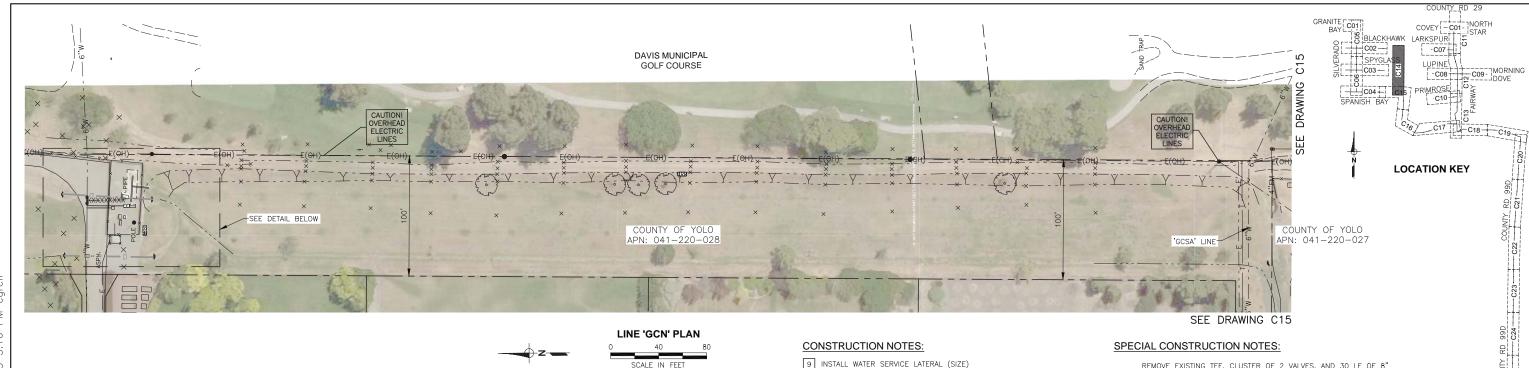

-EXISTING WELL SITE (8"/9 LF) 1 14-2 (E) LANDSCAPE IRRIGATION BACKFLOW PREVENTOR ASSEMBLY ()WELL SITE DETAIL

SCALE: 1"=10'

9 INSTALL WATER SERVICE LATERAL (SIZE)

INSTALL METER WITH VALVES, ANODE AND BOX PER DETAIL 4, SHT DO3 AND CONNECT TO EXISTING IRRIGATION SERVICE. LOCATE EXISTING PIPE AT EXISTING BACKFLOW PREVENTER AND INSTALL METER ON SUPPLY SIDE OF BACKFLOW (SIZE)

INSTALL 1-INCH SERVICE THROUGH ANGLE METER STOP VALVE WITH METER BOX AND PIPE STUB AFTER VALVE PER CITY STANDARD FOR FUTURE PRESSURE SENSOR/TRANSDUCER (BY OTHERS). NO METER REQUIRED.

REMOVE EXISTING TEE, CLUSTER OF 2 VALVES, AND 30 LF OF 8"
PIPE TO SOUTH. CAP AND ABANDON EXISTING PIPE FROM WELL. THIS
WORK SHALL NOT BE PERFORMED UNTIL ALL OTHER PIPE
CONSTRUCTION IS COMPLETED, TESTED, FLUSHED, AND READY TO BE
PUT INTO SERVICE. COORDINATE WELL DISCONNECTION WITH REMOVAL
OF BACKFLOW PREVENTION AT CONNECTION TO CITY SYSTEM PER
NOTE 25-3 ON SHEET C25.

INSTALL NEW PIPE IN PLACE OF REMOVED VALVES, FITTINGS AND PIPE ON EXISTING 8" WATER MAIN. INSTALL 8"%6" REDUCER TO THE EAST. CONNECT WITH ONE CUT—IN SLEEVE AND A BELL AND SPIGOT JOINT. INSTALL UNDER CONTINUOUS INSPECTION.

DESIGNED_AJU DRAWN_ CHECKED KLW REVISION APP'D DATE NO. BY DATE

DESIGN ENGINEER

BY___ASA_J._UTTERBACK ENGINEER'S NAME DATE JANUARY 12, 2018 P.E. C57700 REGISTRATION EXPIRES 12/31/2019




2020 Research Park Drive Suite 100 Davis, California 95618 (530) 756-5905 FAX (530) 756-5991

COUNTY OF YOLO DEPARTMENT OF COMMUNITY SERVICES
IMPROVEMENT PLANS FOR
NORTH DAVIS MEADOWS WATER SYSTEM
CONSOLIDATION PROJECT
GOLF COURSE FAIRWAY NORTH

PLAN AND PROFILE

BID DOCUMENTS SCALE DWG NO C14 AS SHOWN DATE: 12/06/2018 SHEET NO 25 of 36

Meadows\CAD\Production\74614-1601-C14.dwg 12/5/2018 3:16 PM Davis North Yolo\14-16-01 of County L:\Clients\746

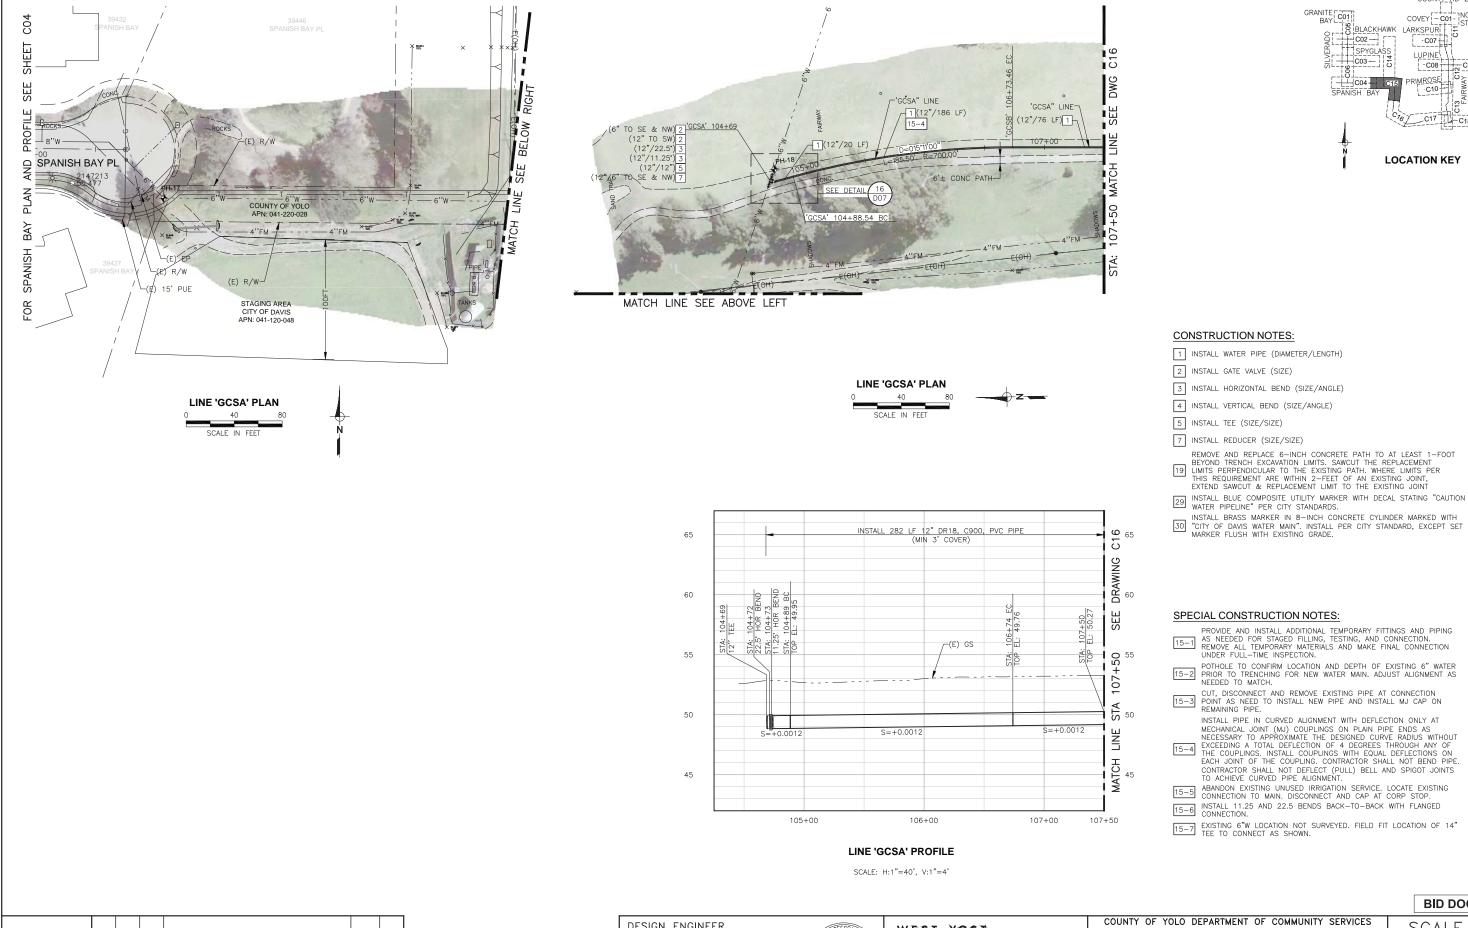

APP'D DATE

 $\stackrel{\forall}{\mathbb{A}}$ 9:26

12/3/2018

Davis

Yolo\14-16-01

of

L:\Clients\746

DESIGNED_AJU

CHECKED KLW

NO. BY DATE

REVISION

DRAWN



2020 Research Park Drive Suite 100 Davis, California 95618 (530) 756-5905 FAX (530) 756-5991

IMPROVEMENT PLANS FOR NORTH DAVIS MEADOWS WATER SYSTEM CONSOLIDATION PROJECT

GOLF COURSE FAIRWAY SOUTH A PLAN AND PROFILE 1

SCALE DWG NO AS SHOWN C15 SHEET NO DATE: 12/06/2018 26 of 36

BID DOCUMENTS

COVEY [-C01-]NORTH

C17 C18

RIMROSE C10


C09 DOVE

RD 99D COUNTY RD 99D C24 C24 C23 C2

DESIGN ENGINEER

ASA J. UTTERBACK ENGINEER'S NAME DATE JANUARY 12, 2018 P.E. C57700

REGISTRATION EXPIRES 12/31/2019

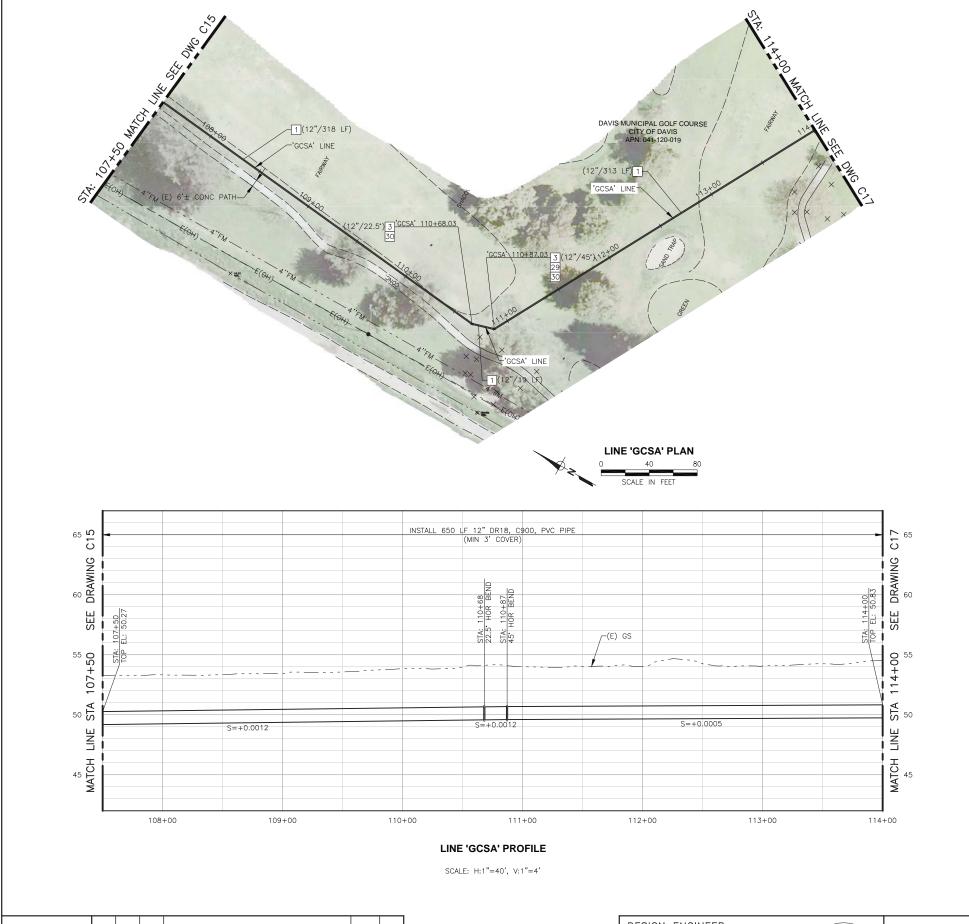

- 1 INSTALL WATER PIPE (DIAMETER/LENGTH)
- 3 INSTALL HORIZONTAL BEND (SIZE/ANGLE)
- 29 INSTALL BLUE COMPOSITE UTILITY MARKER WITH DECAL STATING "CAUTION WATER PIPELINE" PER CITY STANDARDS.

YLUII COVEY - COI NORTH
SBLACKHAWK LARKSPURI STAR
LOO2 - COI STAR
LUPINE!

LOCATION KEY

-C08 C09 DOVE

C03-

install brass marker in 8-inch concrete cylinder marked with "city of davis water main". Install per city standard, except set marker flush with existing grade.

NO.	BY	DATE	REVISION	APP'D	DATE
	NO.	NO. BY	NO. BY DATE	NO. BY DATE REVISION	NO. BY DATE REVISION APP'D

 ${\tt Meadows} \\ {\tt CAD} \\ {\tt Production} \\ \\ {\tt 74614-1601-C15-C17.dwg~12/3/2018~9:26~AM} \\$

North Davis

of $Yolo \ 14-16-01$

County

L:\Clients\746

DESIGN ENGINEER

BY___ASA_J._UTTERBACK ENGINEER'S NAME DATE JANUARY 12, 2018 P.E. C57700 REGISTRATION EXPIRES 12/31/2019





2020 Research Park Drive Suite 100 Davis, California 95618 (530) 756-5905 FAX (530) 756-5991

COUNTY OF YOLO DEPARTMENT OF COMMUNITY SERVICES IMPROVEMENT PLANS FOR NORTH DAVIS MEADOWS WATER SYSTEM CONSOLIDATION PROJECT GOLF COURSE FAIRWAY SOUTH A

PLAN AND PROFILE 2

BID DOCUMENTS SCALE DWG NO AS SHOWN C16 SHEET NO DATE: 12/06/2018 27 оғ 36

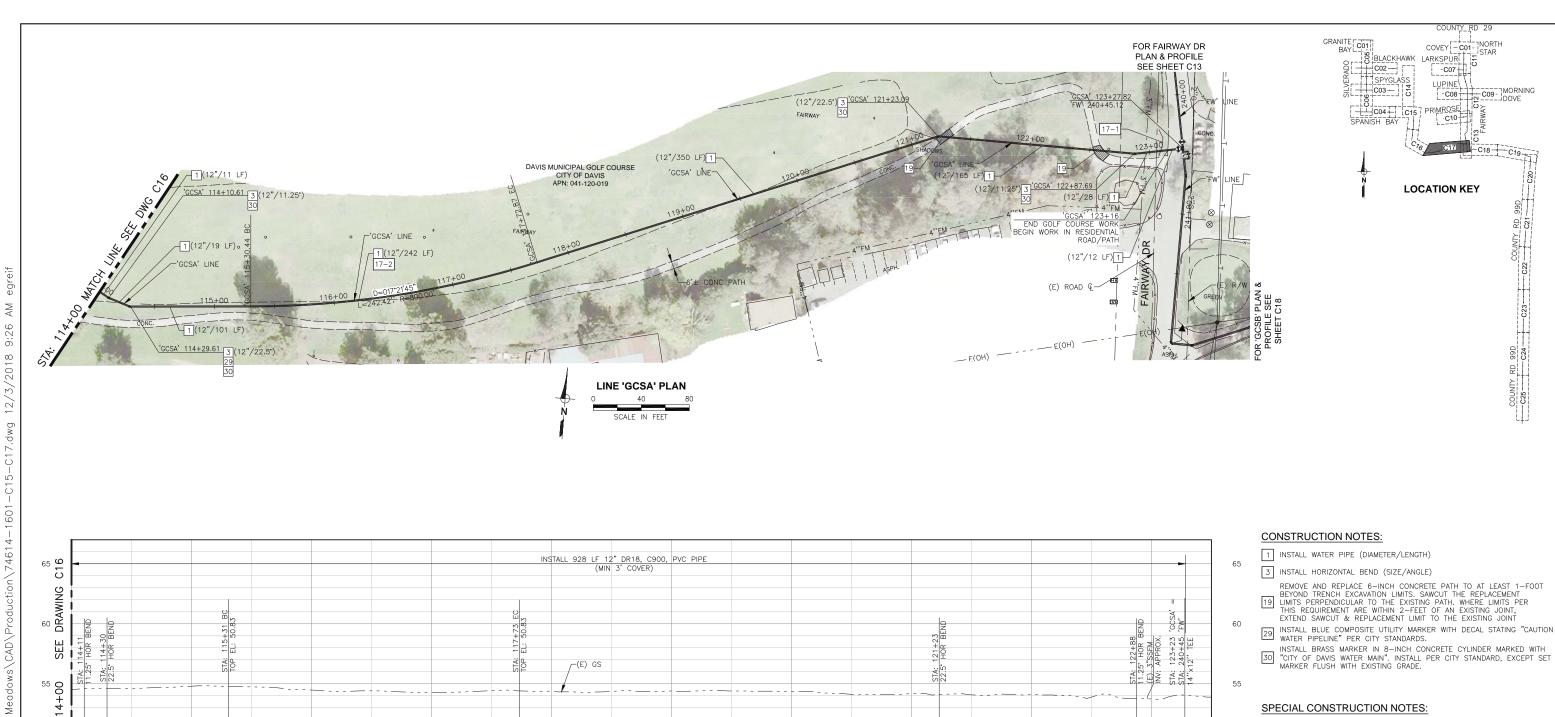

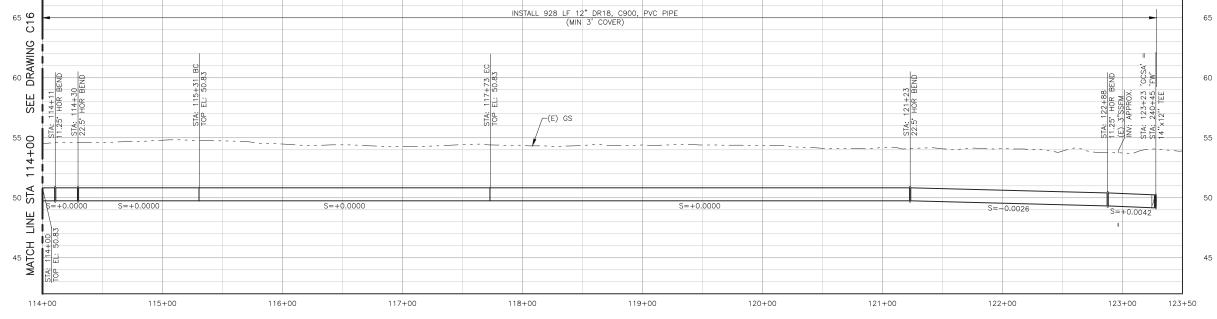

SPECIAL CONSTRUCTION NOTES:

REMOVE AND REPLACE EXISTING SPLIT RAIL FENCE AS NEEDED TO

CONDITION.

INSTALL PIPE IN CURVED ALIGNMENT WITH DEFLECTION ONLY AT MECHANICAL JOINT (MJ) COUPLINGS ON PLAIN PIPE ENDS AS NECESSARY TO APPROXIMATE THE DESIGNED CURVE RADIUS WITHOUT EXCEEDING A TOTAL DEFLECTION OF 4 DEGREES THROUGH ANY OF THE COUPLINGS. INSTALL COUPLINGS WITH EQUAL DEFLECTIONS ON EACH JOINT OF THE COUPLING. CONTRACTOR SHALL NOT BEND PIPE. CONTRACTOR SHALL NOT DEFLECT (PULL) BELL AND SPIGOT JOINTS TO ACHIEVE CURVED PIPE ALIGNMENT.

LINE 'GCSA' PROFILE

SCALE: H:1"=40', V:1"=4'

DESIGNED_AJU DRAWN CHECKED KLW NO. BY DATE REVISION APP'D DATE

Davis

North

Yolo\14-16-01

of

County

L:\Clients\746

DESIGN ENGINEER ASA J. UTTERBACK ENGINEER'S NAME DATE JANUARY 12, 2018 P.E. C57700

REGISTRATION EXPIRES 12/31/2019




2020 Research Park Drive Suite 100 Davis, California 95618 (530) 756-5905 FAX (530) 756-5991

	COUNTY OF YOLO DEPARTMENT OF COMMUNITY SERVICES							
IMPROVEMENT PLANS FOR								
	NORTH DAVIS MEADOWS WATER SYSTEM							
CONSOLIDATION PROJECT								
	GOLF COURSE FAIRWAY SOUTH A							

PLAN AND PROFILE 3

BID DOCUMENTS										
SCALE	DWG NO									
AS SHOWN	C17									
ATE: 12/06/2018	SHEET NO									
	28 of 36									

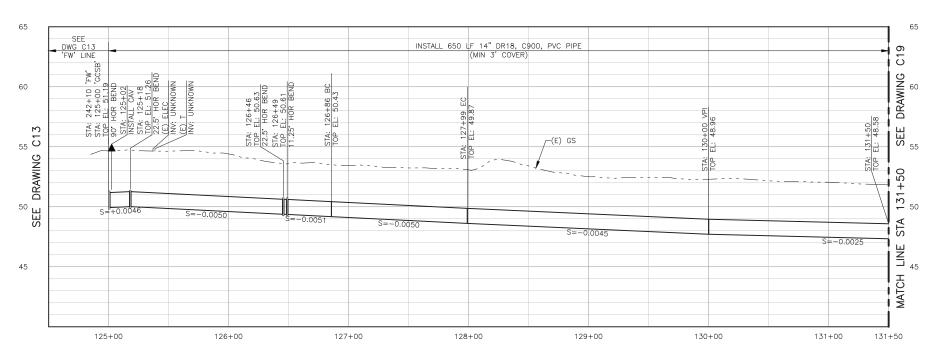

- 1 INSTALL WATER PIPE (DIAMETER/LENGTH)
- 3 INSTALL HORIZONTAL BEND (SIZE/ANGLE)
- INSTALL COMBINATION AIR/VACUUM VALVE ASSEMBLY COMPLETE WITH -INCH SERVICE PER DETAIL 5/SHT DO4

COVEY COULT STAR

PRIMROSE C10

LOCATION KEY

C09- MORNING DOVE

8 BLACKHAWK LARKSPURI
C02 C07
SPYGLASS LUPINE

GRANITE C01

- REMOVE AND REPLACE 6—INCH CONCRETE PATH TO AT LEAST 1—FOOT BEYOND TRENCH EXCAVATION LIMITS. SAWCUT THE REPLACEMENT LIMITS PERPENDICULAR TO THE EXISTING PATH. WHERE LIMITS PER THIS REQUIREMENT ARE WITHIN 2—FEET OF AN EXISTING JOINT, EXTEND SAWCUT & REPLACEMENT LIMIT TO THE EXISTING JOINT
- 29 INSTALL BLUE COMPOSITE UTILITY MARKER WITH DECAL STATING "CAUTION WATER PIPELINE" PER CITY STANDARDS.
- INSTALL BRASS MARKER IN 8-INCH CONCRETE CYLINDER MARKED WITH "CITY OF DAVIS WATER MAIN". INSTALL PER CITY STANDARD, EXCEPT SET MARKER FLUSH WITH EXISTING GRADE.

SPECIAL CONSTRUCTION NOTES:

INSTALL PIPE IN CURVED ALIGNMENT WITH DEFLECTION ONLY AT

INSTALL PIPE IN CURVED ALIGNMENT WITH DEFLECTION ONLY AT MECHANICAL JOINT (MJ) COUPLINGS ON PLAIN PIPE ENDS AS NECESSARY TO APPROXIMATE THE DESIGNED CURVE RADIUS WITHOUT EXCEEDING A TOTAL DEFLECTION OF 4 DEGREES THROUGH ANY OF THE COUPLINGS. INSTALL COUPLINGS WITH EQUAL DEFLECTIONS ON EACH JOINT OF THE COUPLING. CONTRACTOR SHALL NOT BEND PIPE. CONTRACTOR SHALL NOT DEFLECT (PULL) BELL AND SPIGOT JOINTS TO ACHIEVE CURVED PIPE ALIGNMENT.

LINE 'GCSB' PROFILE

SCALE: H:1"=40', V:1"=4'

DESIGNED_AJU						
DRAWNJRR_						
CHECKED_KLW_	NO.	BY	DATE	REVISION	APP'D	DATE

 $\overset{\boxtimes}{\vdash}$

4:09

12/5/2018

Meadows\CAD\Production\74614-1601-C18-C19.dwg

Davis

North

Yolo\14-16-01

of

County

L:\Clients\746

DESIGN ENGINEER ASA J. UTTERBACK ENGINEER'S NAME

DATE JANUARY 12, 2018 P.E. C57700

REGISTRATION EXPIRES 12/31/2019



2020 Research Park Drive Suite 100 Davis, California 95618 (530) 756-5905 FAX (530) 756-5991


COUNTY OF YOLO DEPARTMENT OF COMMUNITY SERVICES IMPROVEMENT PLANS FOR NORTH DAVIS MEADOWS WATER SYSTEM CONSOLIDATION PROJECT


SCALE DWG NO C18 AS SHOWN SHEET NO DATE: 12/06/2018

BID DOCUMENTS

GOLF COURSE FAIRWAY SOUTH B PLAN AND PROFILE 1

29 of 36

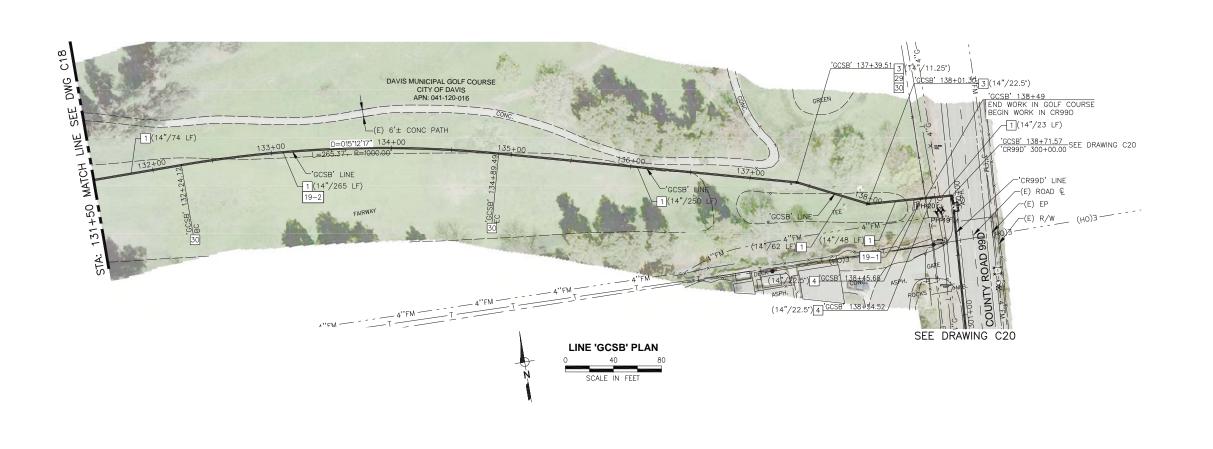

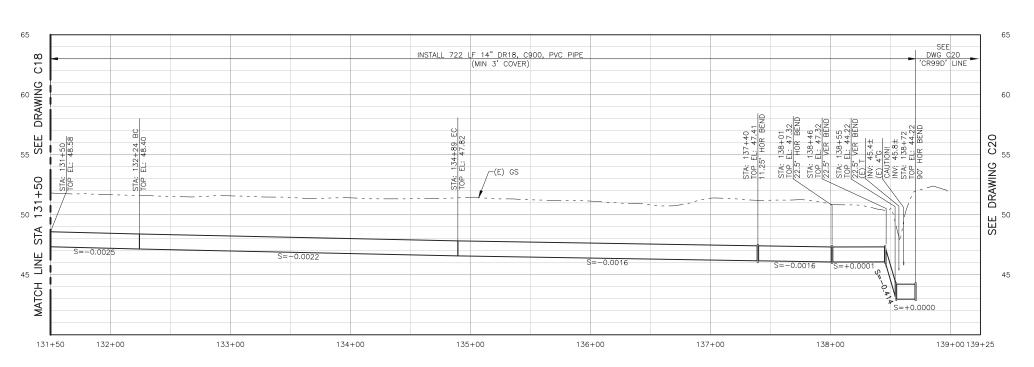

1 INSTALL WATER PIPE (DIAMETER/LENGTH)

GRANITE C01

COVEY - CO1- NORTH

PRIMROSEI C10

LOCATION KEY

C09- MORNING

C03- 5

2 INSTALL GATE VALVE (SIZE)

3 INSTALL HORIZONTAL BEND (SIZE/ANGLE)

4 INSTALL VERTICAL BEND (SIZE/ANGLE)

20 INSTALL 6-INCH BYPASS WITH VALVES PER DETAIL 6, SHT D05

29 INSTALL BLUE COMPOSITE UTILITY MATERIAL PIPELINE" PER CITY STANDARDS. INSTALL BLUE COMPOSITE UTILITY MARKER WITH DECAL STATING "CAUTION

INSTALL BRASS MARKER IN 8-INCH CONCRETE CYLINDER MARKED WITH "CITY OF DAVIS WATER MAIN". INSTALL PER CITY STANDARD, EXCEPT SET MARKER FLUSH WITH EXISTING GRADE.

SPECIAL CONSTRUCTION NOTES:

REMOVE AND REPLACE EXISTING BENCH AND CONCRETE PAD IN KIND AS NEEDED FOR PIPE CONSTRUCTION. RESTORE TO EQUAL OR BETTER CONDITION.

BETTER CONDITION.

INSTALL PIPE IN CURVED ALIGNMENT WITH DEFLECTION ONLY AT MECHANICAL JOINT (MJ) COUPLINGS ON PLAIN PIPE ENDS AS NECESSARY TO APPROXIMATE THE DESIGNED CURVE RADIUS WITHOUT EXCEEDING A TOTAL DEFLECTION OF 4 DEGREES THROUGH ANY OF THE COUPLINGS. INSTALL COUPLINGS WITH EQUAL DEFLECTIONS ON EACH JOINT OF THE COUPLING. CONTRACTOR SHALL NOT BEND PIPE. CONTRACTOR SHALL NOT DEFLECT (PULL) BELL AND SPIGOT JOINTS TO ACHIEVE CURVED PIPE ALIGNMENT.

LINE 'GCSB' PROFILE

SCALE: H:1"=40', V:1"=4'

DESIGNED_AJU						
DRAWNJRR						
CHECKED_KLW_	NO.	BY	DATE	REVISION	APP'D	DATE

 $\overset{\boxtimes}{\vdash}$

12/5/2018 4:09

Meadows\CAD\Production\74614-1601-C18-C19.dwg

Davis

North

Yolo\14-16-01

of

L:\Clients\746 County

DESIGN ENGINEER ASA J. UTTERBACK ENGINEER'S NAME DATE JANUARY 12, 2018 P.E. C57700 REGISTRATION EXPIRES 12/31/2019



2020 Research Park Drive Suite 100 Davis, California 95618 (530) 756-5905 FAX (530) 756-5991 COUNTY OF YOLO DEPARTMENT OF COMMUNITY SERVICES IMPROVEMENT PLANS FOR NORTH DAVIS MEADOWS WATER SYSTEM CONSOLIDATION PROJECT GOLF COURSE FAIRWAY SOUTH B

PLAN AND PROFILE 2

BID DOCUMENTS SCALE DWG NO C19 AS SHOWN SHEET NO DATE: 12/06/2018 30 of 36

