
# OFF-CHANNEL MINING PLAN

# SHIFLER PROPERTY

# YOLO COUNTY, CALIFORNIA

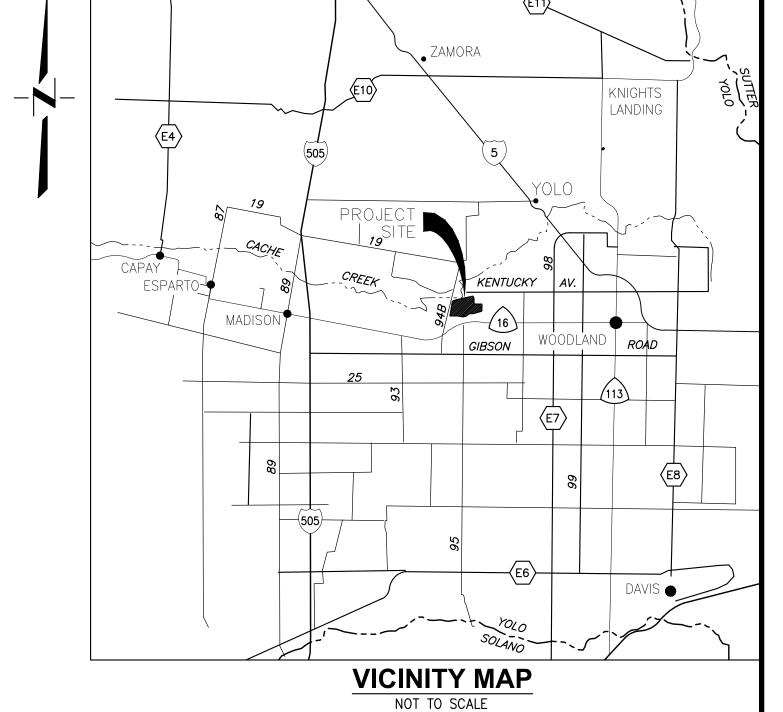

#### **SHEET INDEX:**

M-01 TITLE SHEET

M-02 SITE PLAN

M-03 CROSS SECTION A-A

M-04 CROSS SECTION B-B

M-05 CROSS SECTION C-C

M-06 CROSS SECTION D-D

M-07 CROSS SECTION E-E

M-08 CROSS SECTION F-F

M-09 CROSS SECTION G-G & H-H

#### **BENCHMARK:**

**EXISTING TOPOGRAPHY BASED ON AERIAL** TOPOGRAPHY FLOWN IN APRIL 2010 BY POINT CO. PHOTOGRAMMETRIC SERVICES. AERIAL TARGETS SURVEYED BY LAUGENOUR AND MEIKLE, WOODLAND. **HORIZONTAL DATUM: CA NAD83 ZONE 2 VERTICAL DATUM: NAVD 88** 

#### **ASSESSORS PARCEL NO:**

025-120-32 025-120-33 025-430-02 025-430-01

#### **PROPERTY OWNER:**

SHIFLER LJ FAMILY TRUST INC. **35030 COUNTY ROAD 20** WOODLAND, CA 95851

#### **APPLICANT:**

**TEICHERT AGGREGATES** P.O. BOX 15002 SACRAMENTO, CA 95851 (916) 484-3319

#### **CIVIL ENGINEER:**


**CUNNINGHAM ENGINEERING** 2940 SPAFFORD STREET, SUITE 200 DAVIS, CALIFORNIA 95618 (530) 758-2026

## **DRAWING STATUS:**

PLAN REVIEW SET — NOT FOR CONSTRUCTION O PERMIT SET

# SHIFLER MINING PLAN

# FEBRUARY 2016

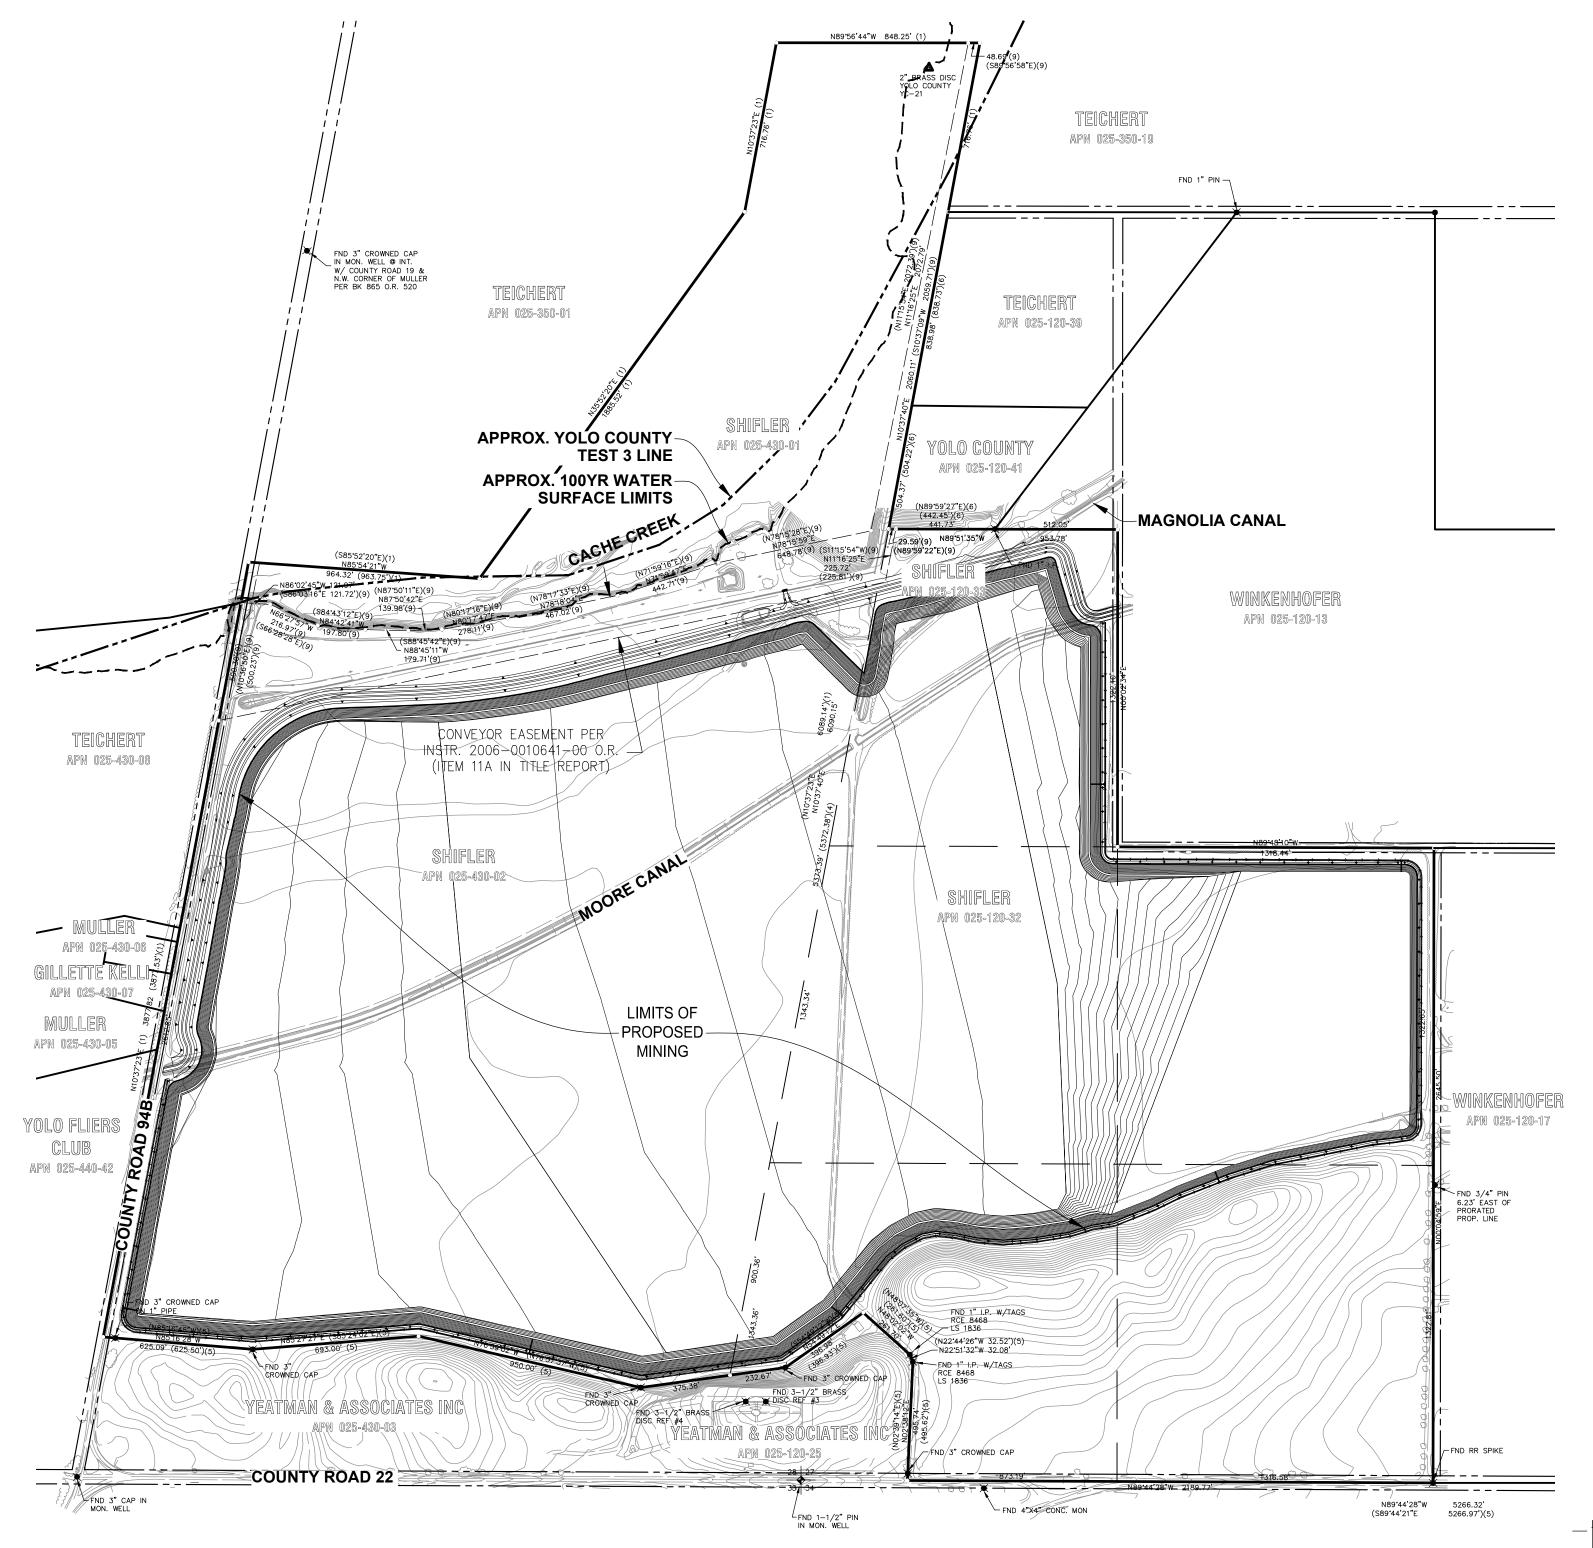

#### **LEGEND:**

APPROXIMATE YOLO **COUNTY TEST 3 LINE** 

APPROXIMATE 100YR

WATER SURFACE LIMITS

**GENERAL NOTES:** 

COMMENCING MINING.

LEVEL TO BE  $\frac{3}{4}$ :1 (H:V).

**ABBREVIATIONS:** 

**AGRICULTURAL** 

ABOVE MEAN SEA LEVEL

ASSESSOR'S PARCEL NUMBER

CODE OF FEDERAL REGULATIONS

AGGREGATE

**AVERAGE** 

CY

**CENTER LINE** 

**CUBIC YARDS** 

ELEVATION

FLOW LINE

FINISH GRADE

GRADE BREAK

HORIZONTAL

**GROUND WATER** 

CONDITIONS LISTED IN THE CONSENT AGREEMENT.

DATED DECEMBER 22, 2015, UPDATED FEBRUARY 2016.

INFORMATION SHALL BE SUBMITTED TO THE COUNTY.

1. ALL WORK SHALL CONFORM TO THE YOLO COUNTY OFF-CHANNEL MINING ORDINANCE (ORD. #1190), THE PROJECT SPECIFIC CONDITIONS OF APPROVAL, THE PROJECT

STORM WATER POLLUTION PREVENTION PLAN (SWPPP), THE SURFACE MINING AND

EXISTING TOPOGRAPHY BASED ON AERIAL TOPOGRAPHY FLOWN IN APRIL 2010 BY POINT CO. PHOTOGRAMMETRIC SERVICES; VERIFY EXISTING CONDITIONS PRIOR TO

ANY WORK THAT NEEDS TO BE PERFORMED WITHIN PG&E'S OR ANY OTHER UTILITY COMPANY'S EASEMENT WILL REQUIRE A CONSENT AGREEMENT FROM THE APPROPRIATE UTILITY COMPANY. USE CAUTION WHEN OPERATING ANY VEHICLES OR EQUIPMENT NEAR OVERHEAD AND UNDERGROUND ELECTRIC FACILITIES. COMPLY WITH ALL

THE DEPTH OF MINING AND THE LIMIT-OF-MINING LINES ARE ONLY APPROXIMATE, AND

ARE SUBJECT TO CHANGE BASED ON THE AMOUNT AND QUALITY OF MATERIAL UNCOVERED, AND THE ABILITY OF THE PRODUCER TO MEET THE RECLAMATION REQUIREMENTS. THE FORESEEABLE ESTIMATE OF VARIATION IS  $\pm /-$  10' IN MINING

HIGH AND LOW AVERAGE GROUNDWATER ELEVATIONS BASED ON "GROUNDWATER

CONDITIONS IN THE VICINITY OF PLANNED WETPIT MINING OPERATIONS, SHIFFLER PROPERTY" AND "CONTOURS OF PREDICTED GROUNDWATER ELEVATION, AVERAGE FALL LOW, POST-RECLAMATION",, BY LUHDORFF & SCALMANINI CONSULTING ENGINEERS

MAXIMUM INCLINATION OF MINING SLOPES ABOVE THE SUMMER LOW GROUNDWATER

PROVIDE PROTECTION TO WET PIT AREAS FROM STORMWATER AND/OR AGRICULTURAL RUNOFF THROUGH THE PLACEMENT OF BERMS AND/OR SWALES. (THIS NOTE MAY NOT APPLY OR BE REQUIRED IF EXISTING TOPOGRAPHY PREVENTS SURFACE RUNOFF FROM ENTERING ANY OF THE MINING EXCAVATIONS THAT EXPOSE GROUNDWATER.)

IF HUMAN SKELETAL REMAINS ARE ENCOUNTERED DURING EXCAVATION, ALL WORK

RESOURCES, SUCH AS CHIPPED OR GROUND STONE, HISTORIC DEBRIS, BUILDING

EXCAVATION, THEN ALL WORK WITHIN SEVENTY-FIVE (75) FEET SHALL IMMEDIATELY STOP AND THE DIRECTOR SHALL BE NOTIFIED AT ONCE. ANY CULTURAL RESOURCES

CORONER SHALL BE NOTIFIED WITHIN TWENTY-FOUR (24) HOURS. IF ANY CULTURAL

FOUND ON THE SITE SHALL BE RECORDED BY A QUALIFIED ARCHAEOLOGIST AND THE

DURING OPERATIONS. THE SITE SHALL BE KEPT FREE OF DEBRIS AND MAINTAINED IN

UNSIGHTLY CONDITIONS. OVERBURDEN SHALL BE STOCKPILED AND STUMPS, BRUSH,

OR OTHER DEBRIS RESULTING FROM EXCAVATION AND/OR PROCESSING SHALL BE

OPEN PITS SHALL BE FENCED WITH A FOUR STRAND BARBED WIRE FENCE OR THE

EQUIVALENT, PRIOR TO THE COMMENCEMENT OF EXCAVATION. FENCING MAY ENCLOSE

THE PROPERTY OF WHICH THE MINING SITE IS A PART, THE MINING SITE, OR BOTH.

IN ADDITION, SIGNS SHALL BE INSTALLED AT THE PROJECT SITE BOUNDARIES AND

WITHIN SEVENTY-FIVE (75) FEET SHALL IMMEDIATELY STOP, AND THE COUNTY

FOUNDATIONS, OR PALEONTOLOGICAL MATERIALS ARE ENCOUNTERED DURING


A NEAT AND ORDERLY MANNER SO AS NOT TO CREATE ANY HAZARDOUS OR

10. UNNECESSARY PERSONNEL SHALL BE EXCLUDED FROM OFF-CHANNEL EXCAVATIONS.

ACCESS ROAD, INDICATING THAT THE EXCAVATION AREA IS A DANGER ZONE.

DEPTH; AND +/- 20% OF AREA FOR EACH TYPE OF RECLAMATION.

RECLAMATION ACT (SMARA), OSHA, MSHA, AND OTHER APPLICABLE LOCAL, STATE AND

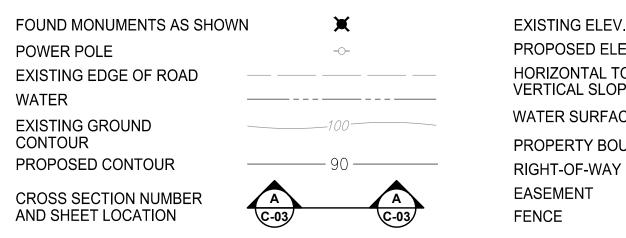

\_\_\_\_30.0 PROPOSED ELEV. HORIZONTAL TO **VERTICAL SLOPE** WATER SURFACE PROPERTY BOUNDARY **RIGHT-OF-WAY** \_\_\_\_\_\_\_\_ **EASEMENT FENCE** — x — x — x — x — x —

**IRRIGATION** 

MONITOR WELL

NOT IN CONTRACT

PROPERTY LINE

**RIGHT-OF-WAY** 

RECLAMATION

SAND AND GRAVEL

RADIUS

SLOPE

**VERTICAL** 

WEST

YEAR

YR

**ORIGINAL GROUND ELEVATION** 

MINE SAFETY AND HEALTH ADMINISTRATION

OCCUPATIONAL SAFETY AND HEALTH ADMINISTRATION

× 195.0

NO. DATE REVISIONS BY DESIGNED BY NC DRAWN BY NC/LR CHECKED BY SG SCALE AS SHOWN

**TEICHERT AGGREGATES** 



**KEY MAP** 

1"=400'


CECWEST.COM Project Planning 
Civil Engineering 
Landscape Architecture ■ Sacramento Office ■ Davis Off 20 20th Street, Suite Three 2940 Spafford Street, Suite 200 Sacramento, CA 95818 Davis, CA 95618 (916) 455-2026 (530) 758-2026


YOLO COUNTY


TITLE SHEET

**M-01** 9 DATE: \_\_02/11/16

JOB NO: 1129.20 CALIFORNIA

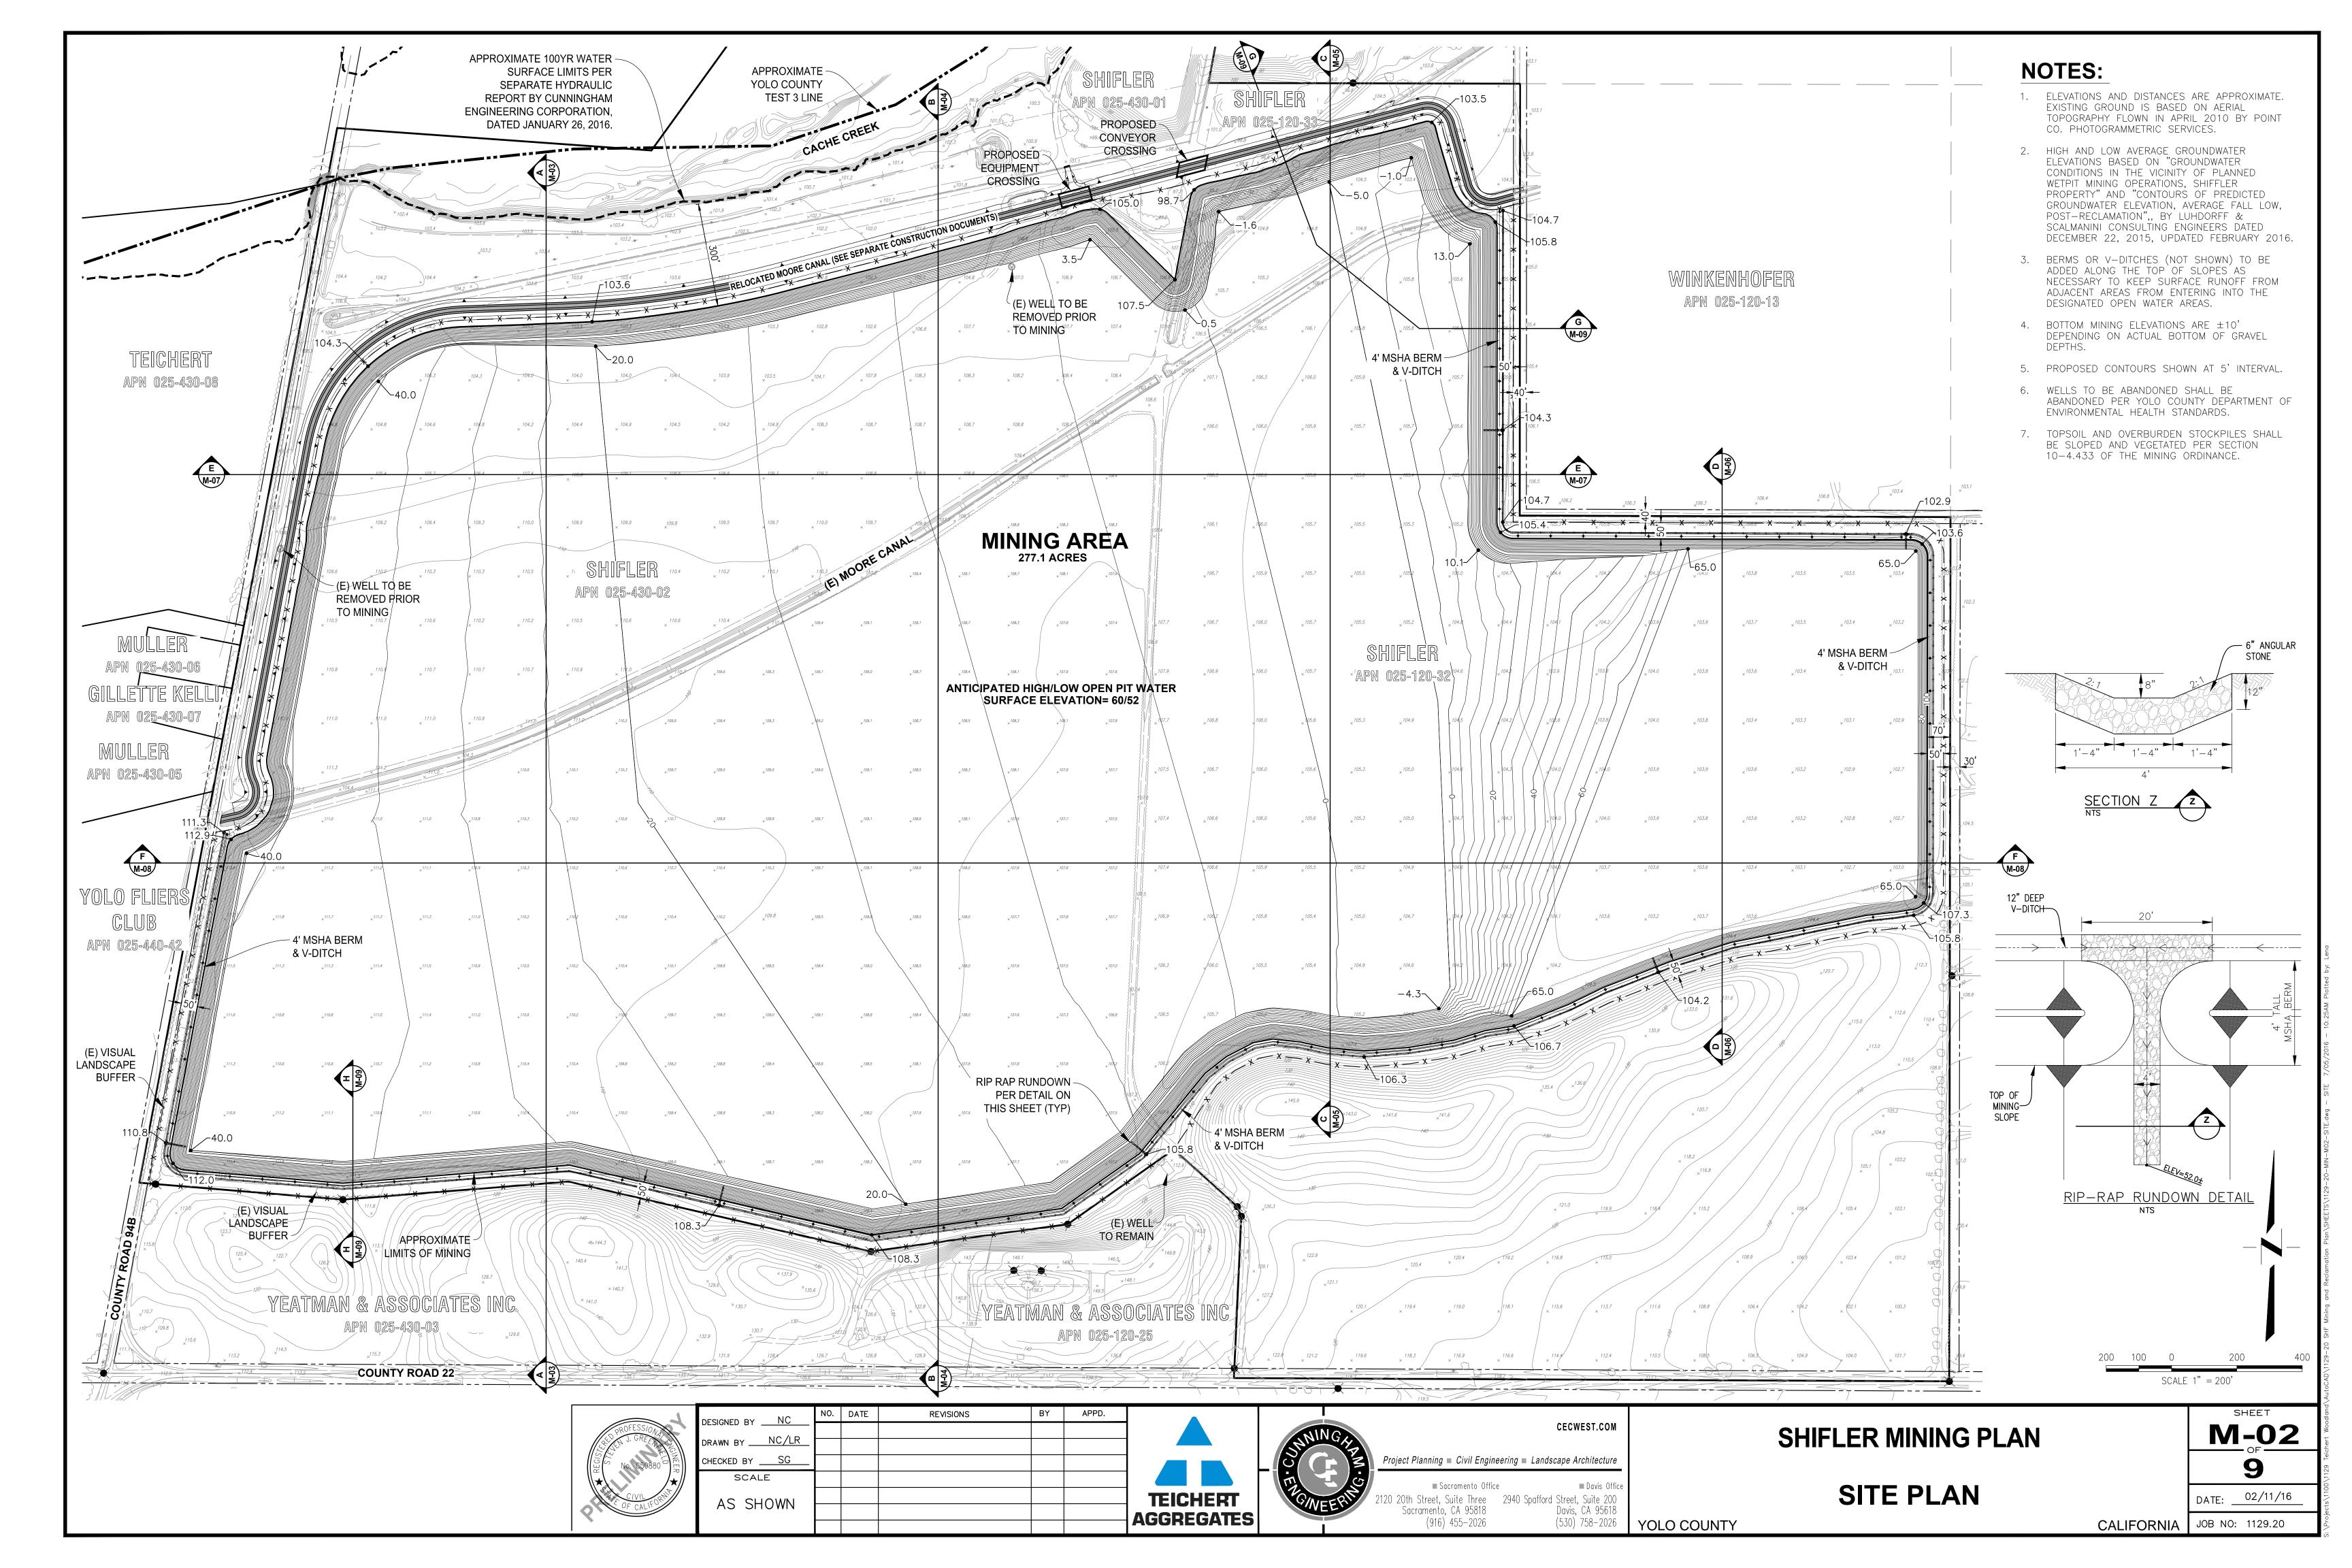

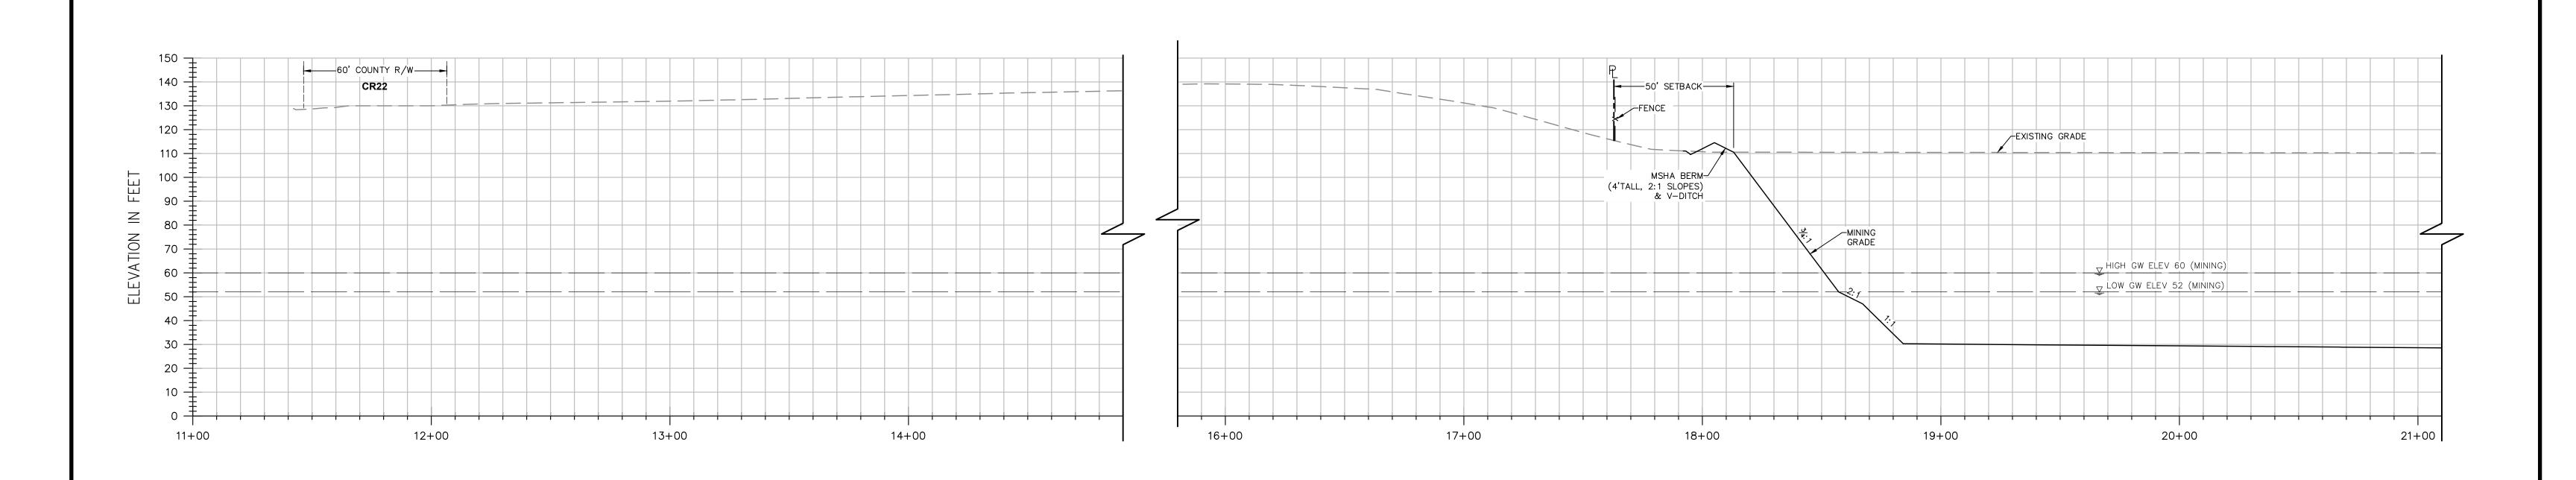

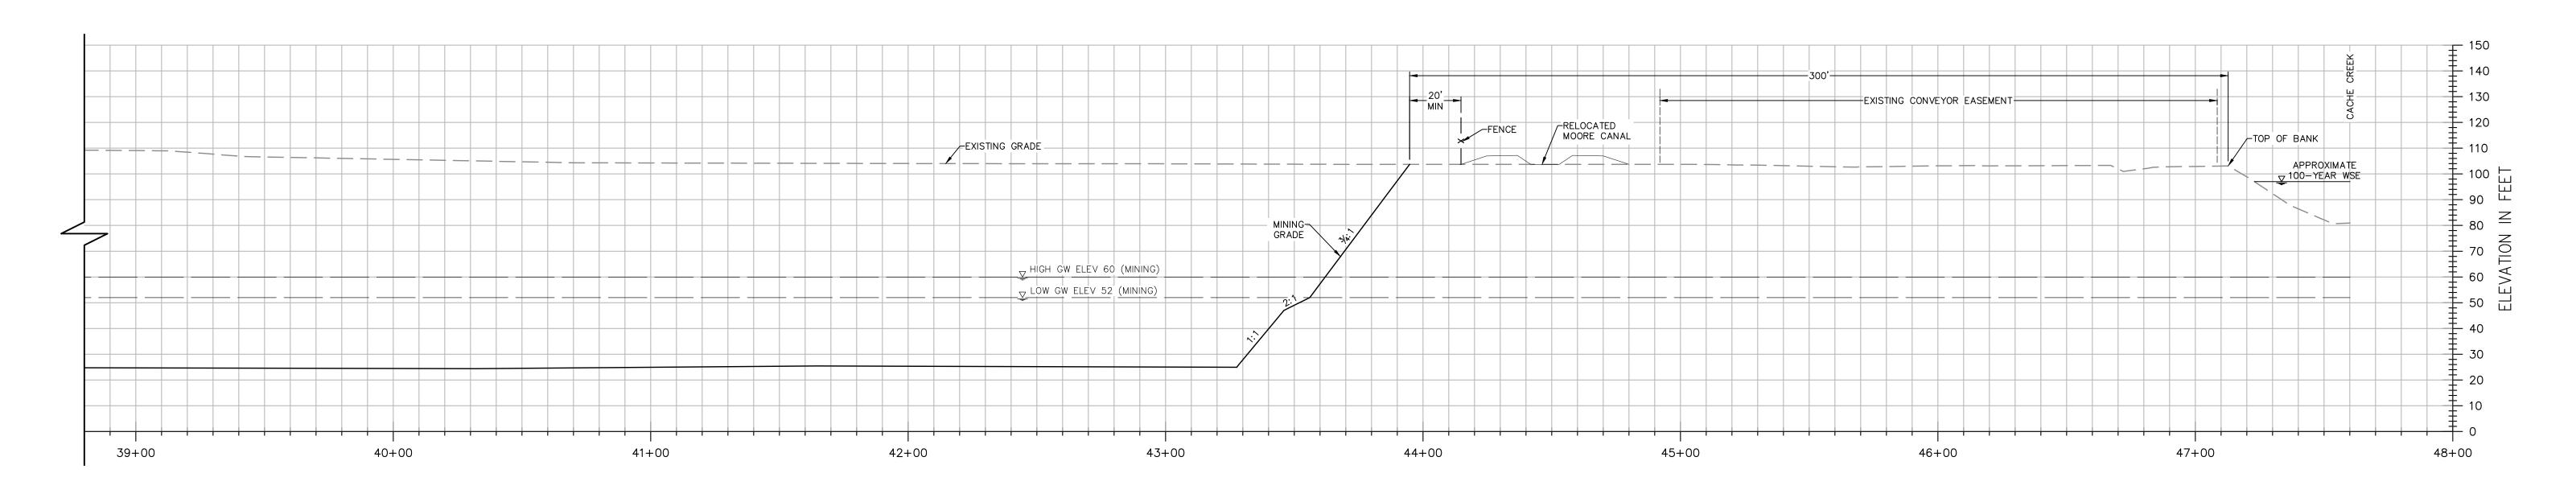

# **SECTION A-A**

H: 1"=30', V: 1"=30'

### **NOTES:**

- 1. ELEVATIONS AND DISTANCES ARE APPROXIMATE. EXISTING GROUND IS BASED ON AERIAL TOPOGRAPHY FLOWN IN APRIL 2010 BY POINT CO. PHOTOGRAMMETRIC SERVICES.
- 2. HIGH AND LOW AVERAGE GROUNDWATER ELEVATIONS BASED ON "GROUNDWATER CONDITIONS IN THE VICINITY OF PLANNED WETPIT MINING OPERATIONS, SHIFFLER PROPERTY" AND "CONTOURS OF PREDICTED GROUNDWATER ELEVATION, AVERAGE FALL LOW, POST-RECLAMATION", BOTH BY LUHDORFF & SCALMANINI CONSULTING ENGINEERS DATED DECEMBER 22, 2015, UPDATED FEBRUARY 2016.
- 3. BERMS OR V—DITCHES TO BE ADDED ALONG THE TOP OF SLOPES AS NECESSARY TO KEEP SURFACE RUNOFF FROM ADJACENT AREAS FROM ENTERING INTO THE DESIGNATED OPEN WATER AREAS.
- 4. BOTTOM MINING ELEVATIONS ARE ±10' DEPENDING ON ACTUAL BOTTOM OF GRAVEL DEPTHS.


30 15 0 30 6

SCALE 1" = 30'HOR.

SCALE 1" = 30'VERT.



DESIGNED BY NC	NO.	DATE	REVISIONS	BY	APPD.	
DRAWN BYNC/LR_						
CHECKED BY SG						
SCALE						
AS SHOWN						
713 3110 1111						1

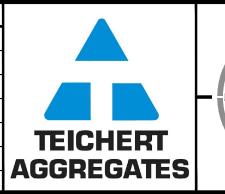



CECWEST.COM
eering ■ Landscape Architecture

Project Planning ■ Civil Engineering ■ Landscape Architecture


■ Sacramento Office
2120 20th Street, Suite Three Sacramento, CA 95818 Davis, CA 95618 (916) 455-2026 (530) 758-2026


YOLO COUNTY

SHIFLER MINING PLAN
CROSS SECTION A-A

M-03 9

DATE: 02/11/16

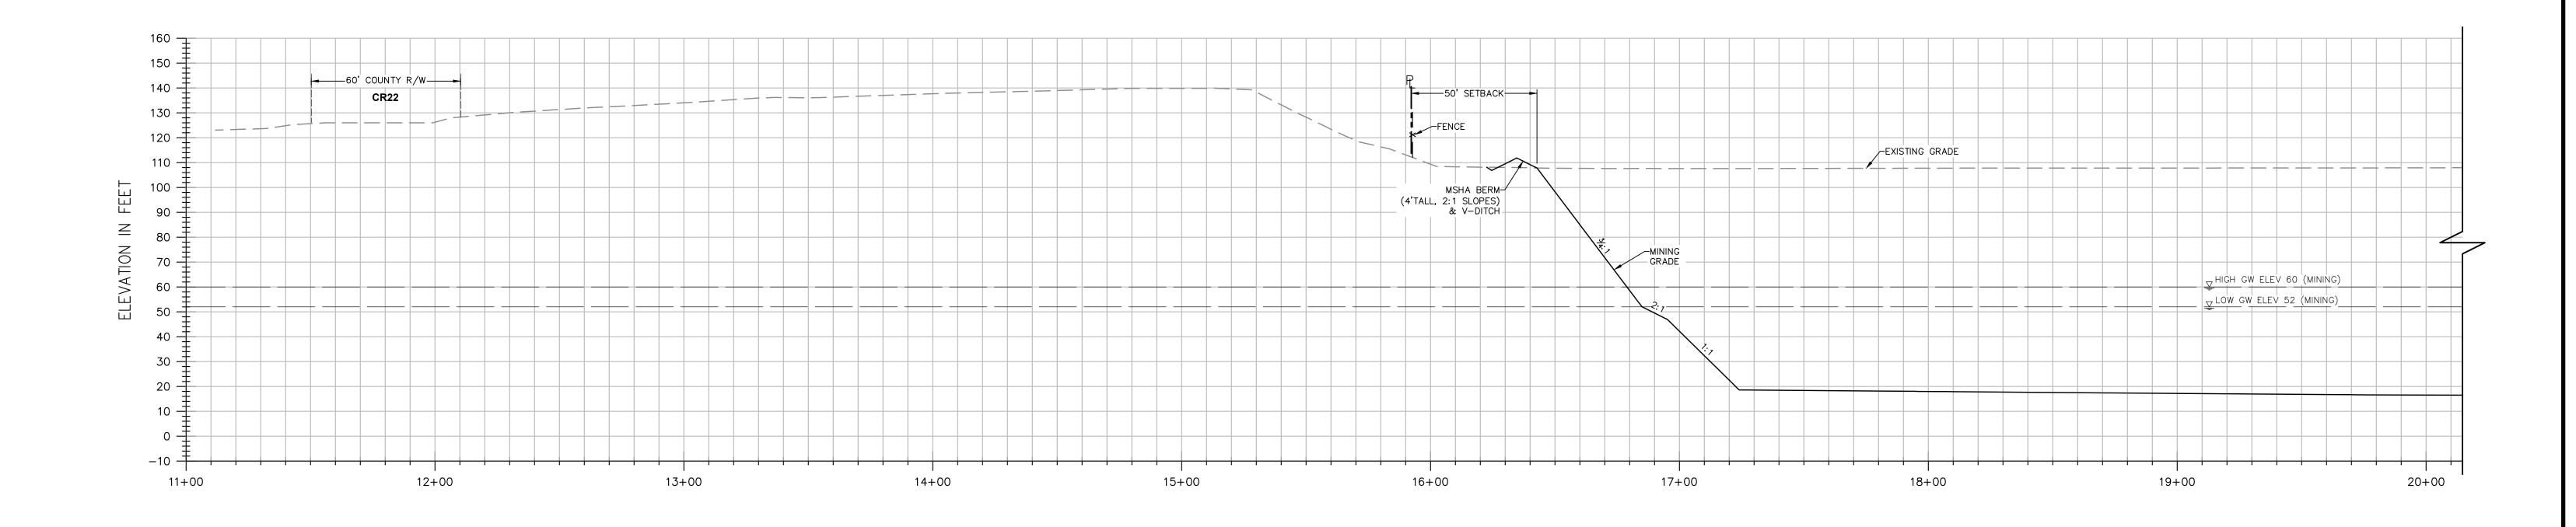

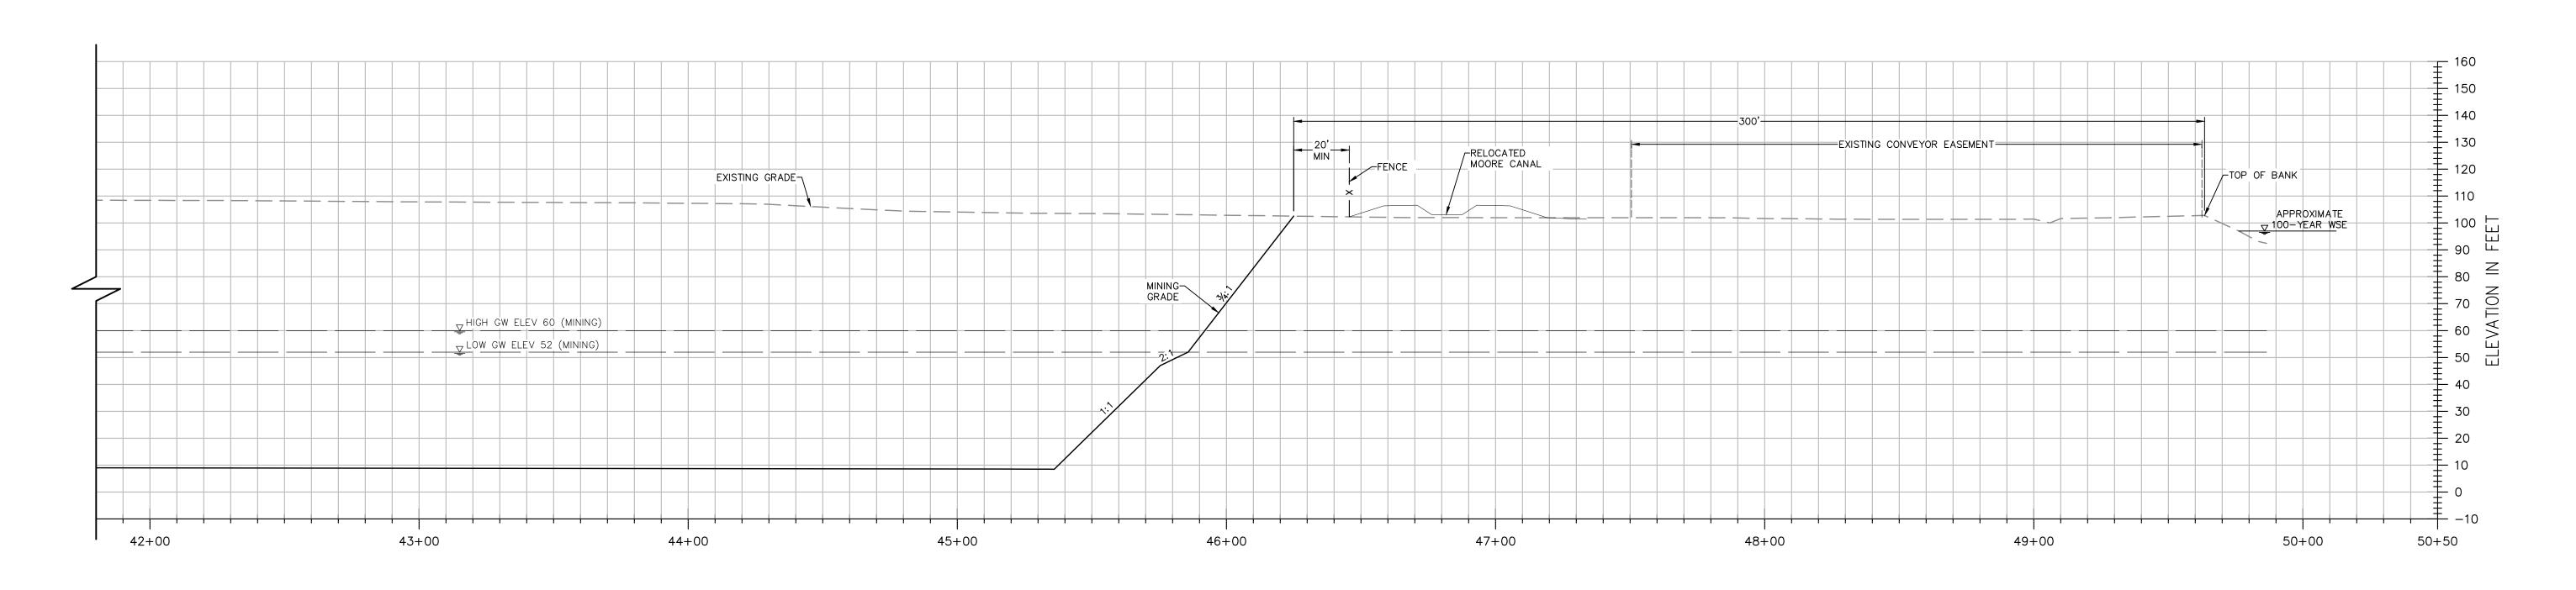

## **SECTION B-B**

### **NOTES:**


- 1. ELEVATIONS AND DISTANCES ARE APPROXIMATE. EXISTING GROUND IS BASED ON AERIAL TOPOGRAPHY FLOWN IN APRIL 2010 BY POINT CO. PHOTOGRAMMETRIC SERVICES.
- 2. HIGH AND LOW AVERAGE GROUNDWATER ELEVATIONS BASED ON "GROUNDWATER CONDITIONS IN THE VICINITY OF PLANNED WETPIT MINING OPERATIONS, SHIFFLER PROPERTY" AND "CONTOURS OF PREDICTED GROUNDWATER ELEVATION, AVERAGE FALL LOW, POST-RECLAMATION", BOTH BY LUHDORFF & SCALMANINI CONSULTING ENGINEERS DATED DECEMBER 22, 2015, UPDATED FEBRUARY 2016.
- 3. BERMS OR V—DITCHES TO BE ADDED ALONG THE TOP OF SLOPES AS NECESSARY TO KEEP SURFACE RUNOFF FROM ADJACENT AREAS FROM ENTERING INTO THE DESIGNATED OPEN WATER AREAS.
- 4. BOTTOM MINING ELEVATIONS ARE  $\pm 10^{\circ}$  DEPENDING ON ACTUAL BOTTOM OF GRAVEL DEPTHS.

SCALE 1" = 30'HOR. SCALE 1" = 30'VERT.



DESIGNED BY NC	NO.	DATE	REVISIONS	BY	APPD.	
						İ
DRAWN BYNC/LR_						
CHECKED BY SG						
SCALE						
AS SHOWN						
AS SHOWN						



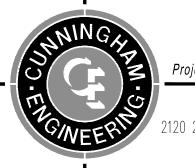

CECWEST.COM

Project Planning ■ Civil Engineering ■ Landscape Architecture ■ Sacramento Office 2120 20th Street, Suite Three Sacramento, CA 95818 2940 Spafford Street, Suite 200 Davis, CA 95618


(916) 455-2026


SHIFLER MINING PLAN **CROSS SECTION B-B** 

**M-04** 9 DATE: 02/11/16

CALIFORNIA JOB NO: 1129.20

(530) 758-2026 YOLO COUNTY

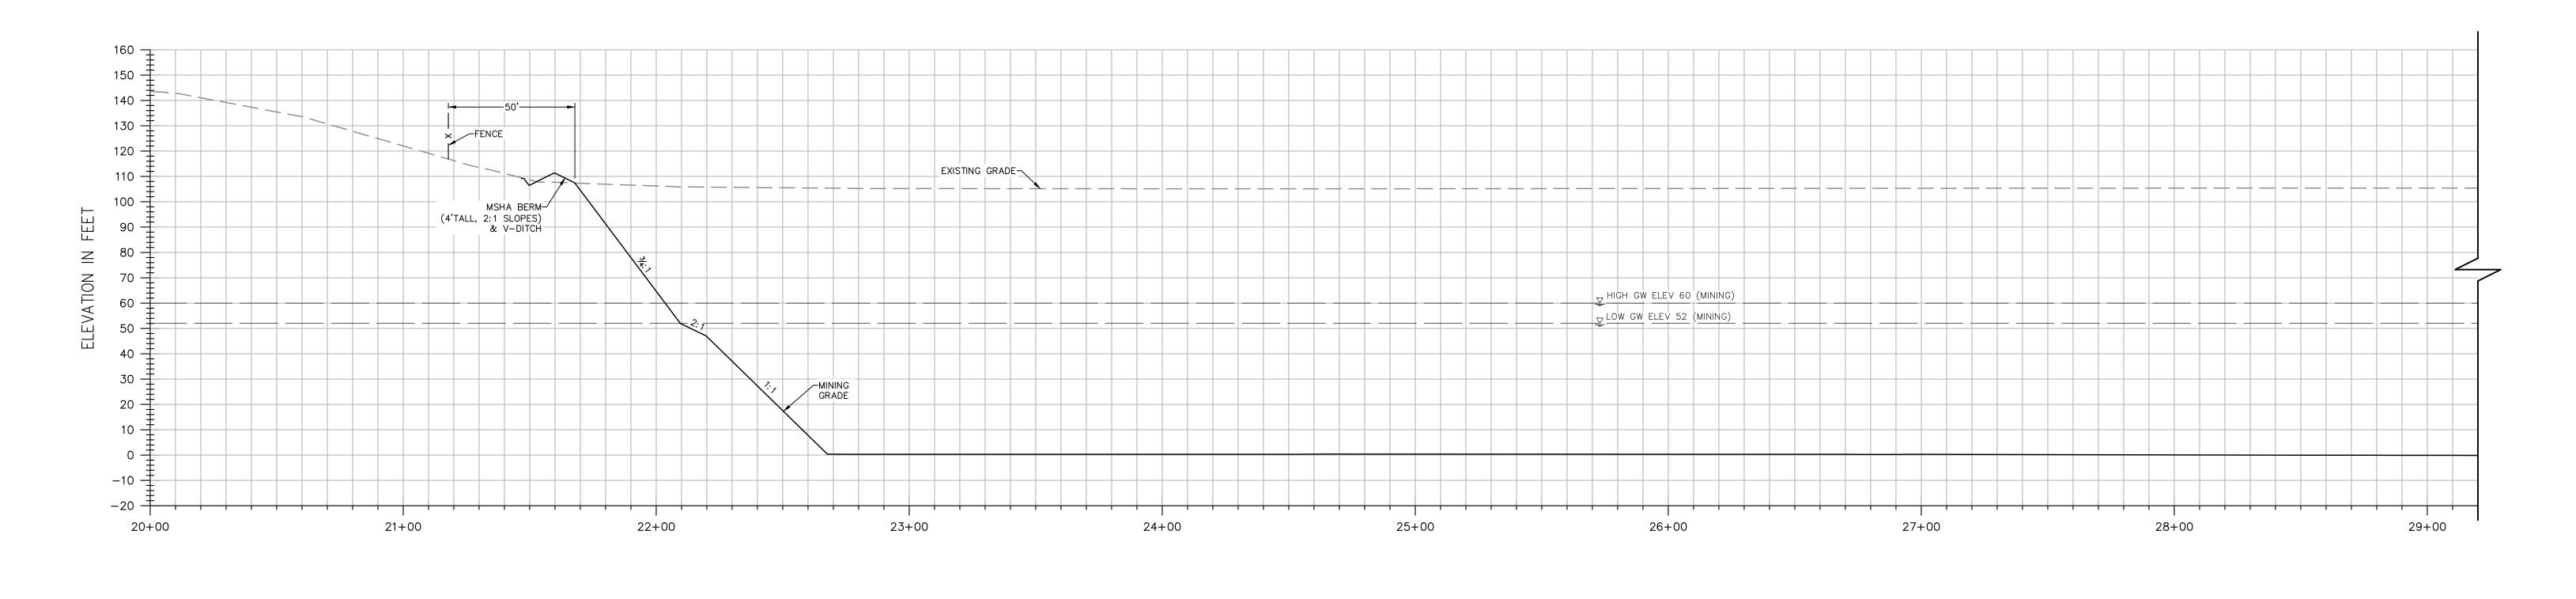

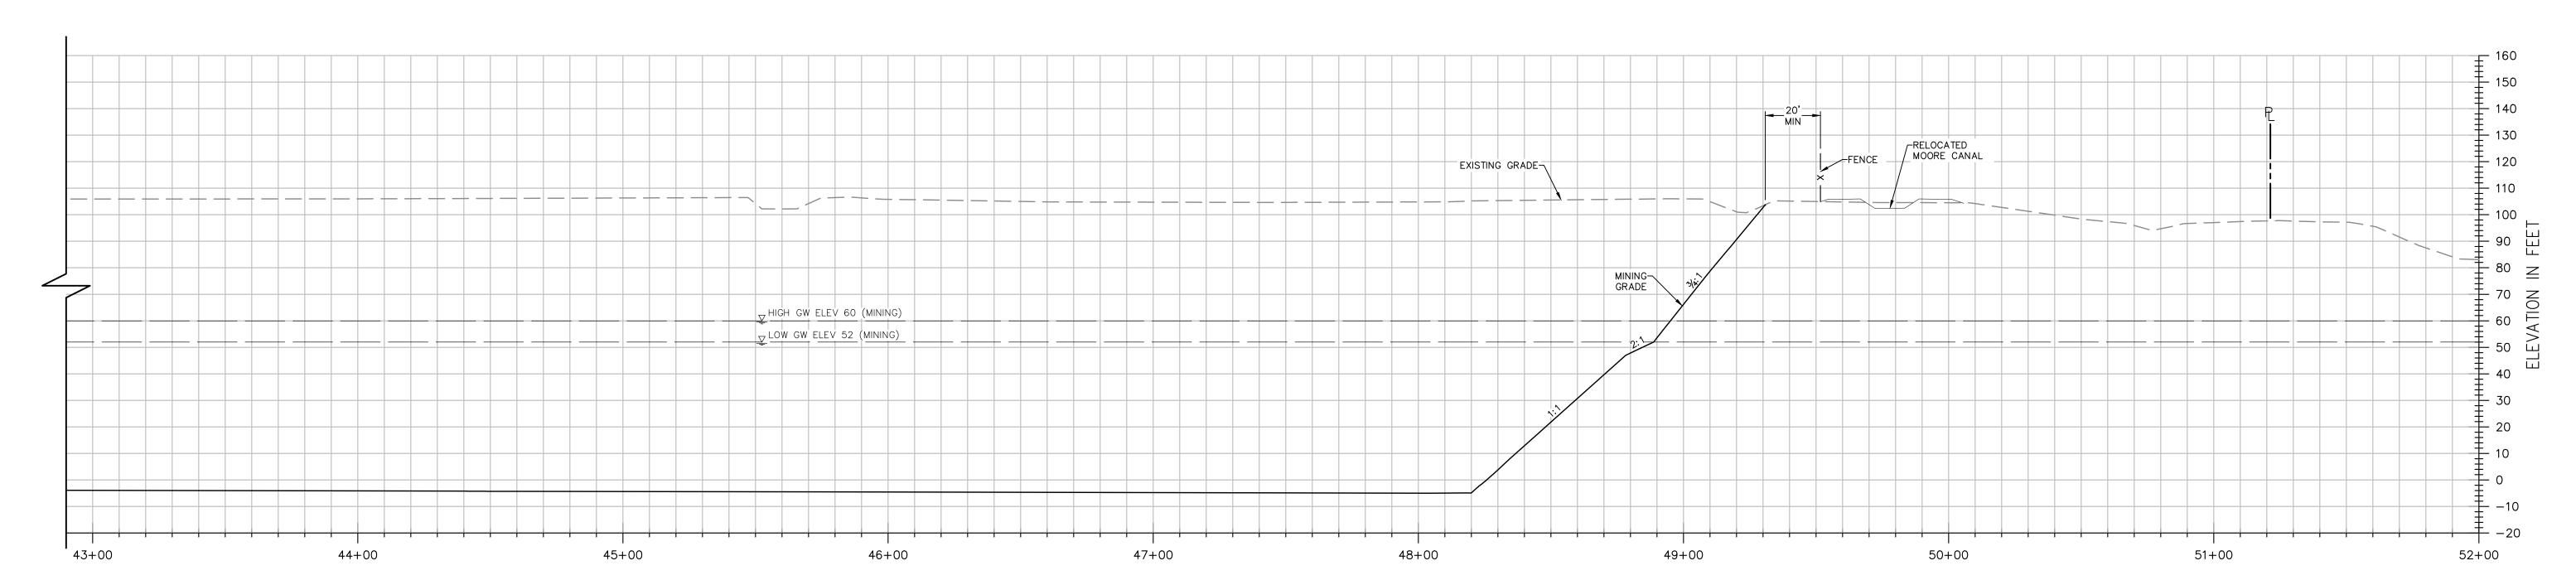

**SECTION C-C** 

H: 1"=30',

### **NOTES:**


- 1. ELEVATIONS AND DISTANCES ARE APPROXIMATE. EXISTING GROUND IS BASED ON AERIAL TOPOGRAPHY FLOWN IN APRIL 2010 BY POINT CO. PHOTOGRAMMETRIC SERVICES.
- 2. HIGH AND LOW AVERAGE GROUNDWATER ELEVATIONS BASED ON "GROUNDWATER CONDITIONS IN THE VICINITY OF PLANNED WETPIT MINING OPERATIONS, SHIFFLER PROPERTY" AND "CONTOURS OF PREDICTED GROUNDWATER ELEVATION, AVERAGE FALL LOW, POST-RECLAMATION", BOTH BY LUHDORFF & SCALMANINI CONSULTING ENGINEERS DATED DECEMBER 22, 2015, UPDATED FEBRUARY 2016.
- 3. BERMS OR V—DITCHES TO BE ADDED ALONG THE TOP OF SLOPES AS NECESSARY TO KEEP SURFACE RUNOFF FROM ADJACENT AREAS FROM ENTERING INTO THE DESIGNATED OPEN WATER AREAS.
- 4. BOTTOM MINING ELEVATIONS ARE ±10' DEPENDING ON ACTUAL BOTTOM OF GRAVEL DEPTHS.

30 15 0 30 SCALE 1" = 30'HOR. SCALE 1" = 30'VERT.



DESIGNED BY NC	NO.	DATE	REVISIONS	BY	APPD.
DRAWN BY NC/LR					
CHECKED BY SG					
SCALE					
AS SHOWN					
AS SHOWN					



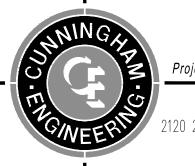

CECWEST.COM

Project Planning ■ Civil Engineering ■ Landscape Architecture

■ Sacramento Office ■ Davis Office


2120 20th Street, Suite Three 2940 Spafford Street, Suite 200
Sacramento, CA 95818 Davis, CA 95618
(916) 455-2026 (530) 758-2026


SHIFLER MINING PLAN
CROSS SECTION C-C

M-05 9

DATE: 02/11/16

(530) 758-2026 **YOLO COUNTY** 

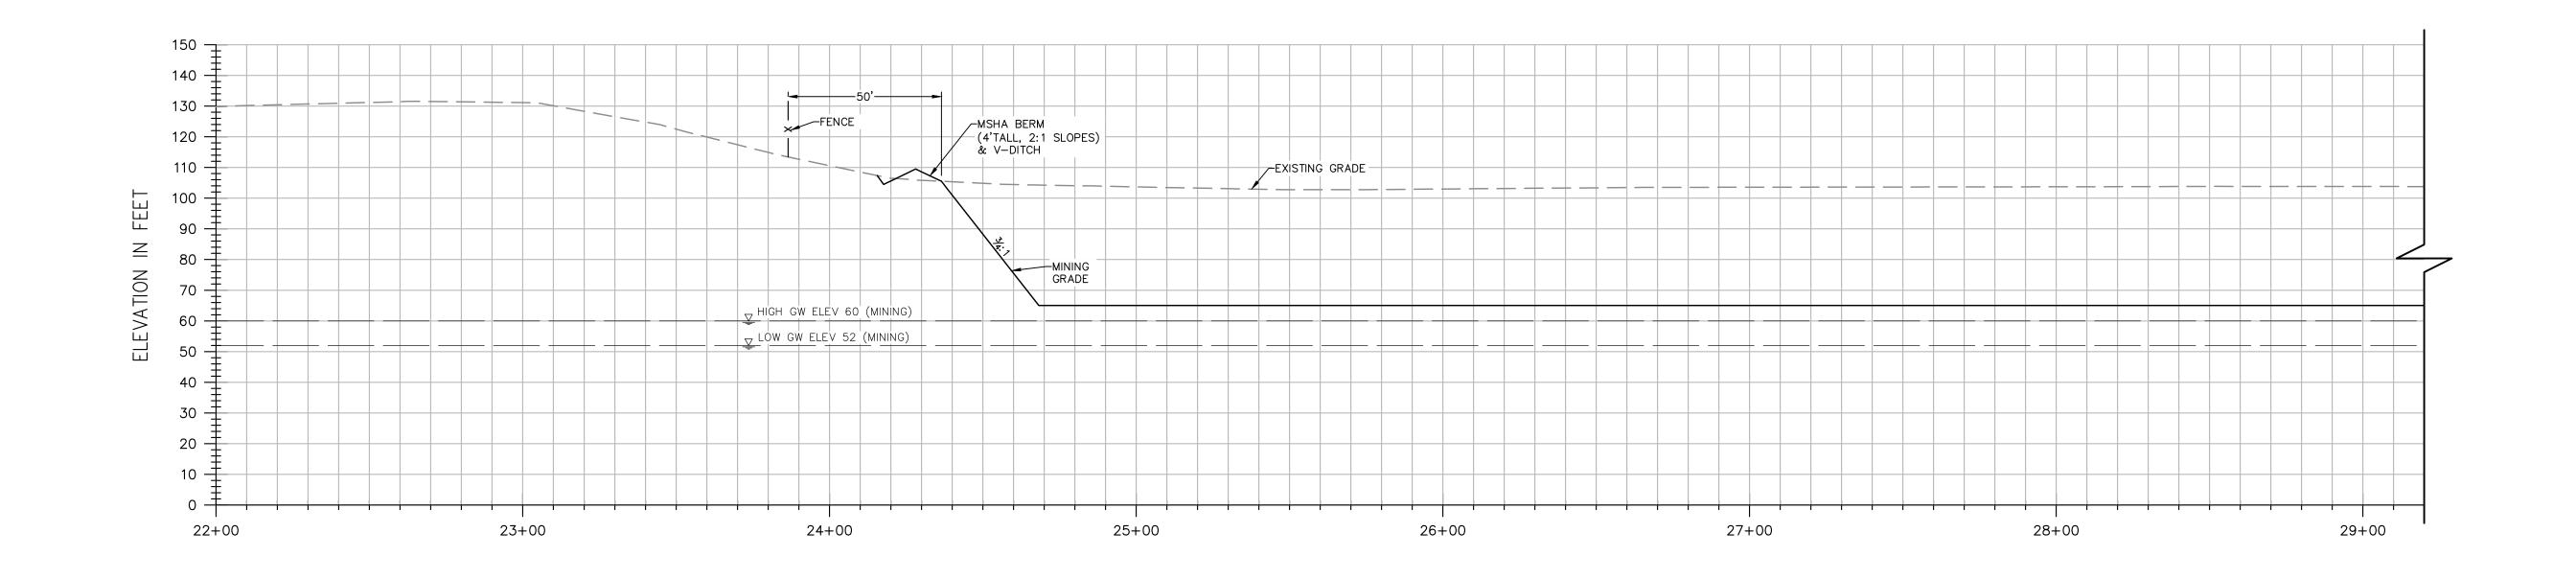

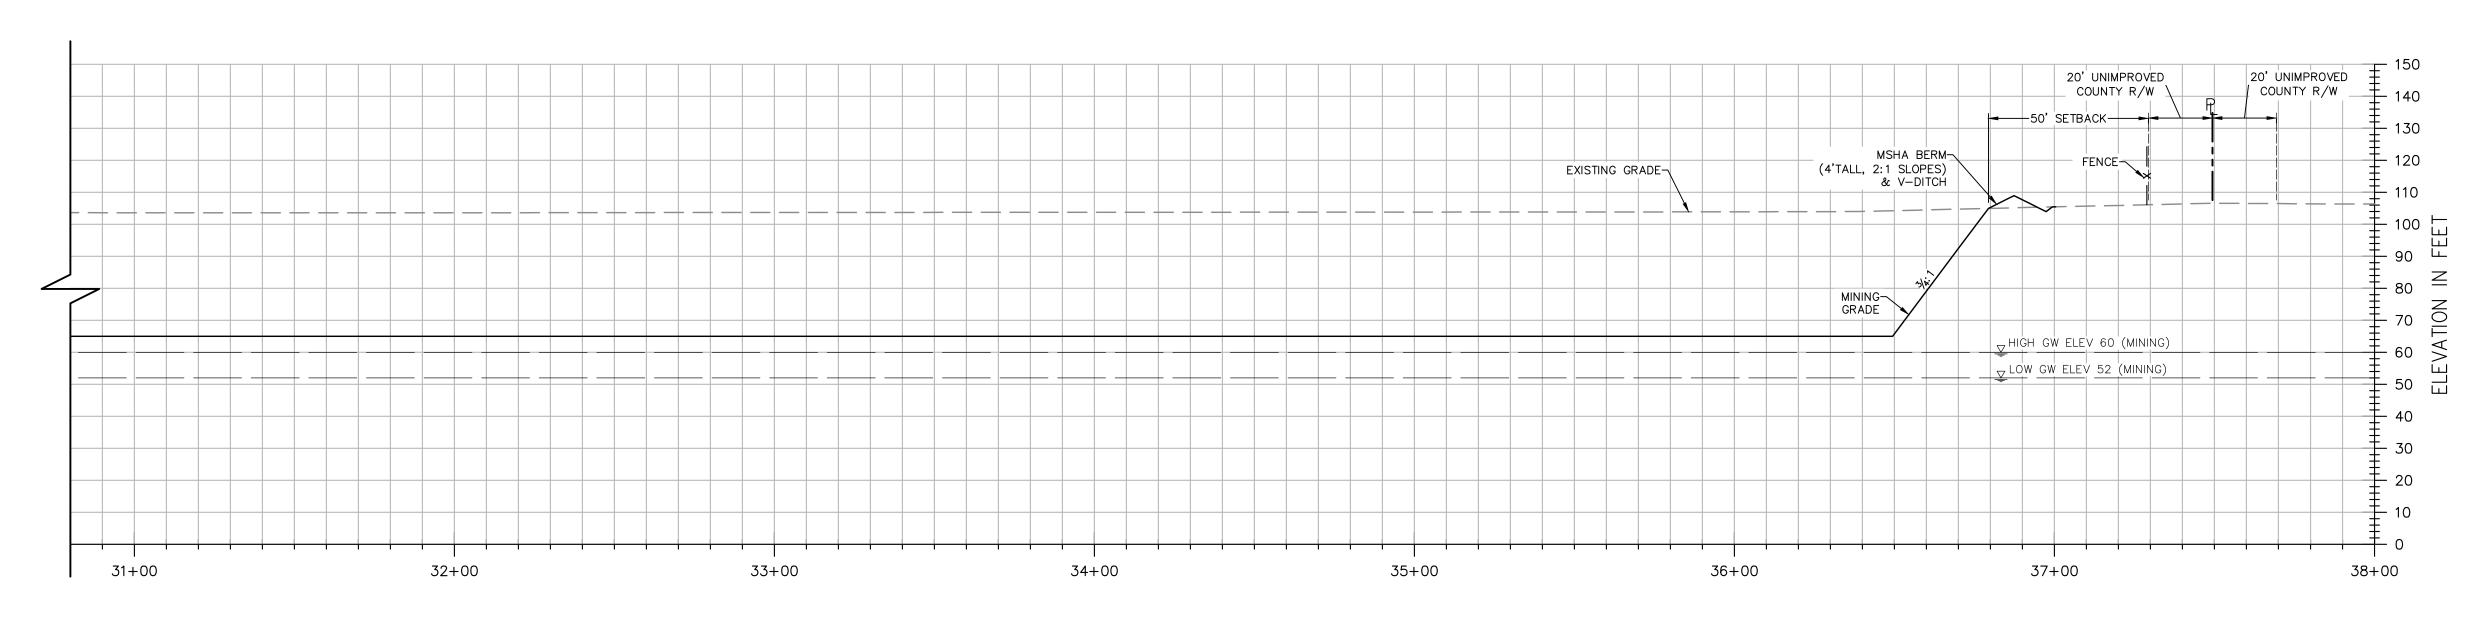

### **SECTION D-D**


### **NOTES:**


- 1. ELEVATIONS AND DISTANCES ARE APPROXIMATE. EXISTING GROUND IS BASED ON AERIAL TOPOGRAPHY FLOWN IN APRIL 2010 BY POINT CO. PHOTOGRAMMETRIC SERVICES.
- 2. HIGH AND LOW AVERAGE GROUNDWATER ELEVATIONS BASED ON "GROUNDWATER CONDITIONS IN THE VICINITY OF PLANNED WETPIT MINING OPERATIONS, SHIFFLER PROPERTY" AND "CONTOURS OF PREDICTED GROUNDWATER ELEVATION, AVERAGE FALL LOW, POST-RECLAMATION", BOTH BY LUHDORFF & SCALMANINI CONSULTING ENGINEERS DATED DECEMBER 22, 2015, UPDATED FEBRUARY 2016.
- 3. BERMS OR V—DITCHES TO BE ADDED ALONG THE TOP OF SLOPES AS NECESSARY TO KEEP SURFACE RUNOFF FROM ADJACENT AREAS FROM ENTERING INTO THE DESIGNATED OPEN WATER AREAS.
- 4. BOTTOM MINING ELEVATIONS ARE  $\pm 10^{\circ}$  DEPENDING ON ACTUAL BOTTOM OF GRAVEL DEPTHS.

SCALE 1" = 30'HOR. SCALE 1" = 30'VERT.



DESIGNED BY NC	NO.	DATE	REVISIONS	BY	APPD.
DRAWN BYNC/LR_					
CHECKED BY SG					
SCALE					
AS SHOWN					
AS SHOWN					

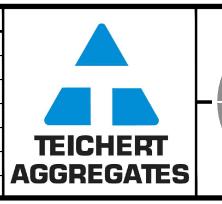

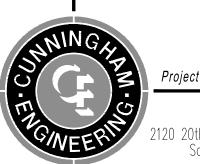

CECWEST.COM


Project Planning 


Civil Engineering 

Landscape Architecture ■ Sacramento Office 2120 20th Street, Suite Three Sacramento, CA 95818 (916) 455—2026 2940 Spafford Street, Suite 200 Davis, CA 95618 (530) 758—2026 (530) 758-2026 YOLO COUNTY

SHIFLER MINING PLAN **CROSS SECTION D-D**  **M-06** 9

DATE: 02/11/16 CALIFORNIA JOB NO: 1129.20

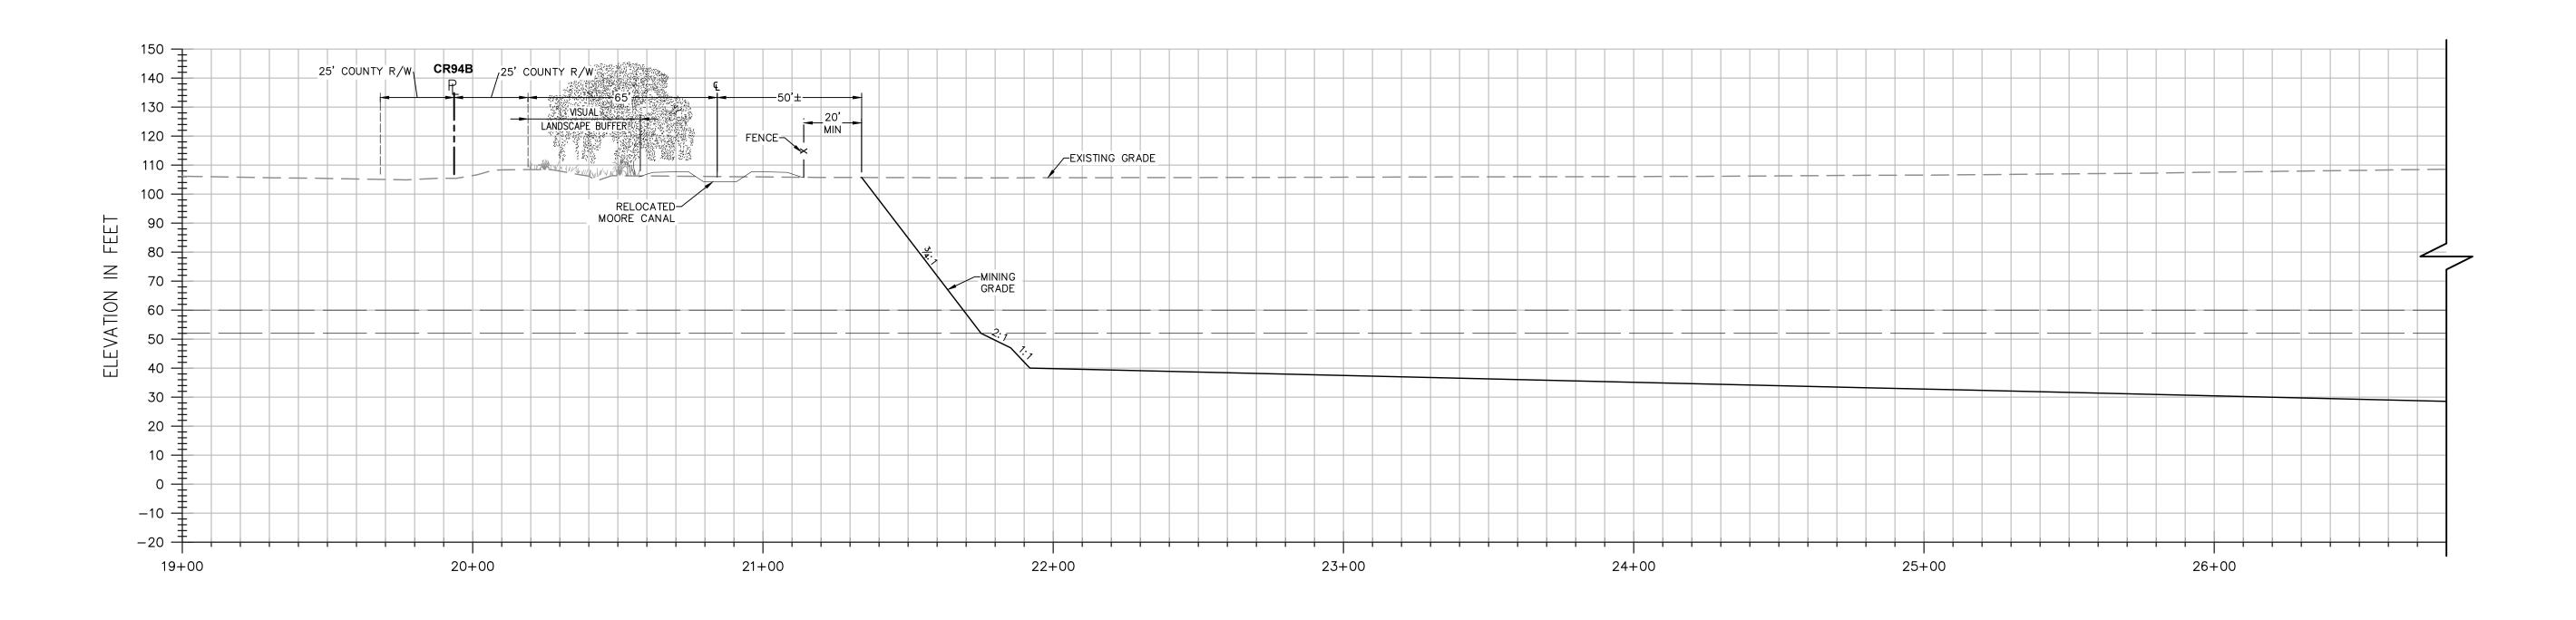

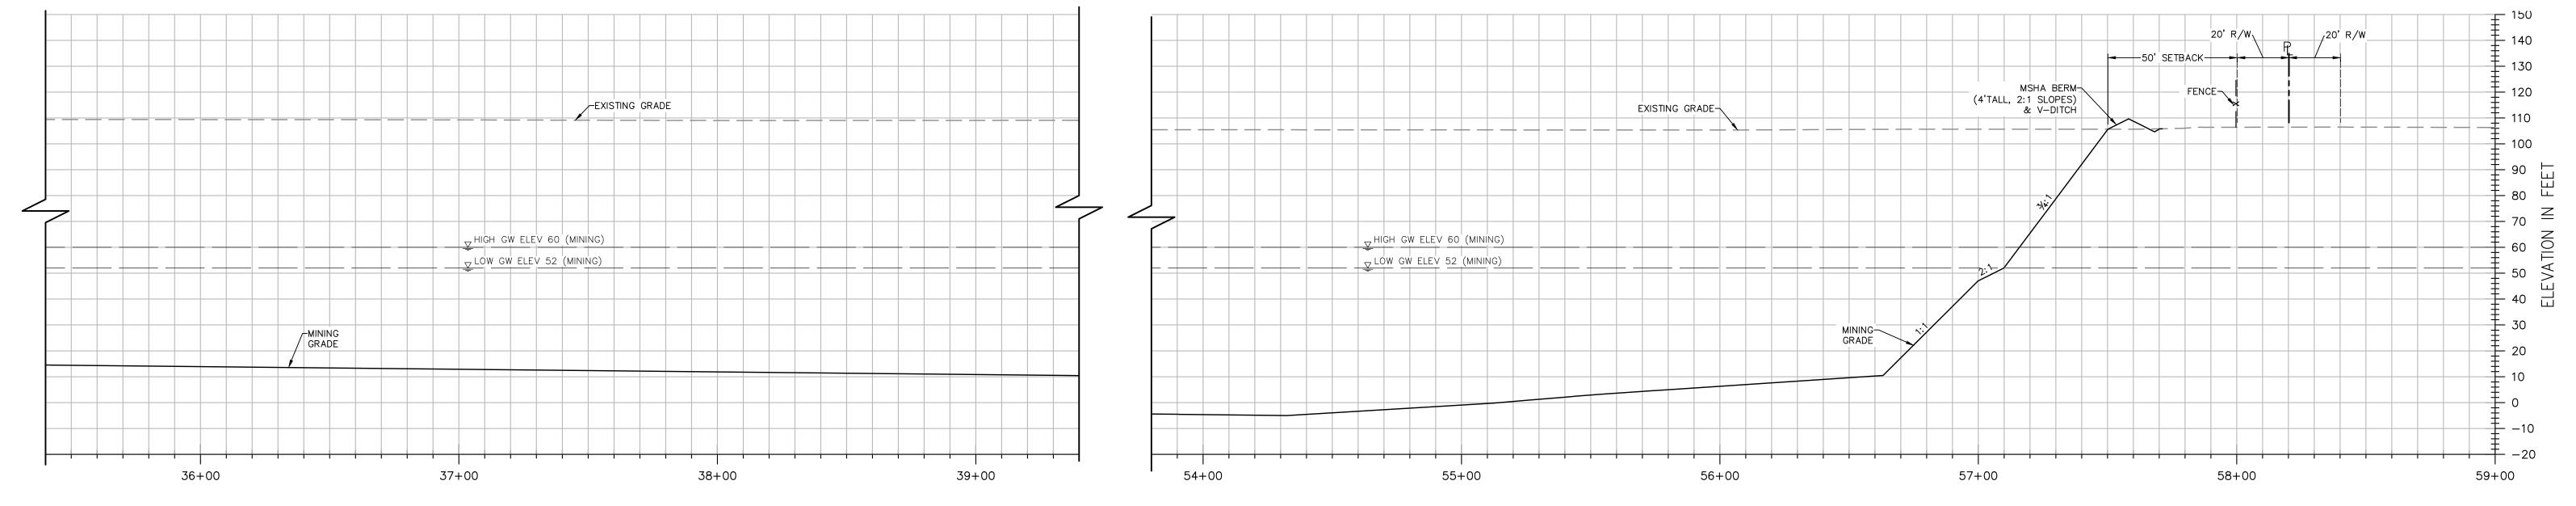

# **SECTION E-E**

H: 1"=30' V: 1"=30'


### NOTES:

- 1. ELEVATIONS AND DISTANCES ARE APPROXIMATE. EXISTING GROUND IS BASED ON AERIAL TOPOGRAPHY FLOWN IN APRIL 2010 BY POINT CO. PHOTOGRAMMETRIC SERVICES.
- 2. HIGH AND LOW AVERAGE GROUNDWATER ELEVATIONS BASED ON "GROUNDWATER CONDITIONS IN THE VICINITY OF PLANNED WETPIT MINING OPERATIONS, SHIFFLER PROPERTY" AND "CONTOURS OF PREDICTED GROUNDWATER ELEVATION, AVERAGE FALL LOW, POST-RECLAMATION", BOTH BY LUHDORFF & SCALMANINI CONSULTING ENGINEERS DATED DECEMBER 22, 2015, UPDATED FEBRUARY 2016.
- 3. BERMS OR V—DITCHES TO BE ADDED ALONG THE TOP OF SLOPES AS NECESSARY TO KEEP SURFACE RUNOFF FROM ADJACENT AREAS FROM ENTERING INTO THE DESIGNATED OPEN WATER AREAS.
- 4. BOTTOM MINING ELEVATIONS ARE  $\pm 10^{\circ}$  DEPENDING ON ACTUAL BOTTOM OF GRAVEL DEPTHS.

30 15 0 30 60 SCALE 1" = 30'HOR. SCALE 1" = 30'VERT.



DESIGNED BY NC	NO.	DATE	REVISIONS	BY	APPD.	
						l
DRAWN BYNC/LR_						
CHECKED BY SG						
SCALE						
AS SHOWN						
AS SHOWN						١,
	l					1

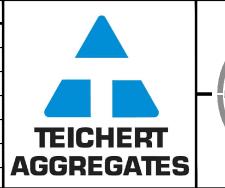



CECWEST.COM

Project Planning ■ Civil Engineering ■ Landscape Architecture

■ Sacramento Office
2120 20th Street, Suite Three 2940 Spafford Street, Suite 200
Sacramento, CA 95818
(916) 455-2026

(530) 758-2026


SHIFLER MINING PLAN


CROSS SECTION E-E

M-07 9 DATE: 02/11/16

DATE: 02/11/16

(530) 758-2026 **YOLO COUNTY** 

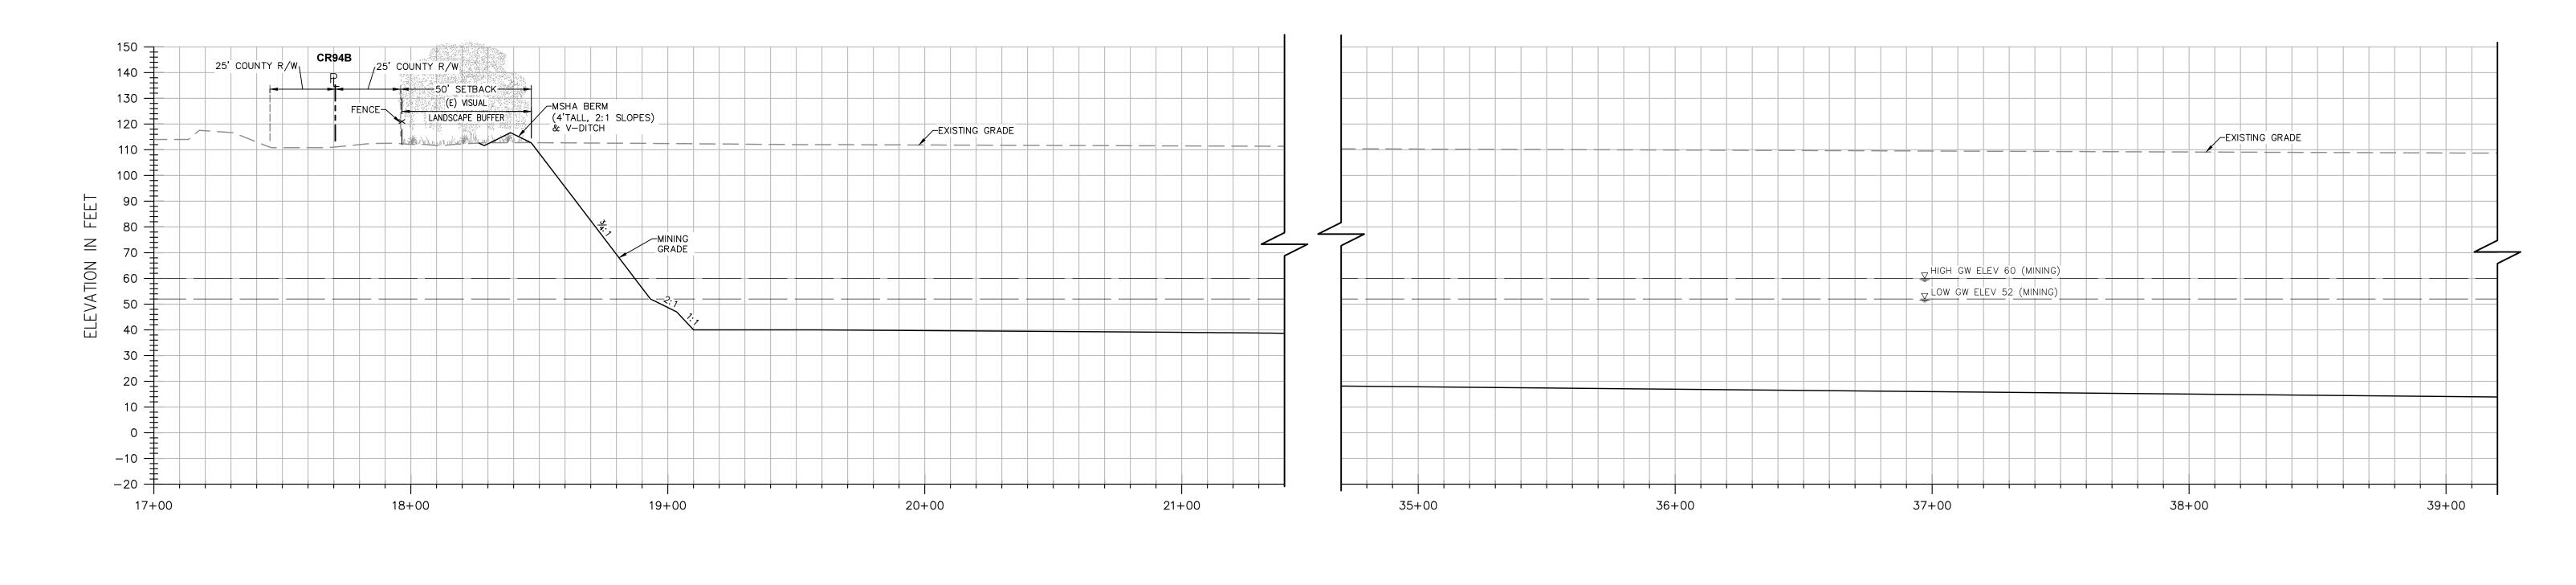

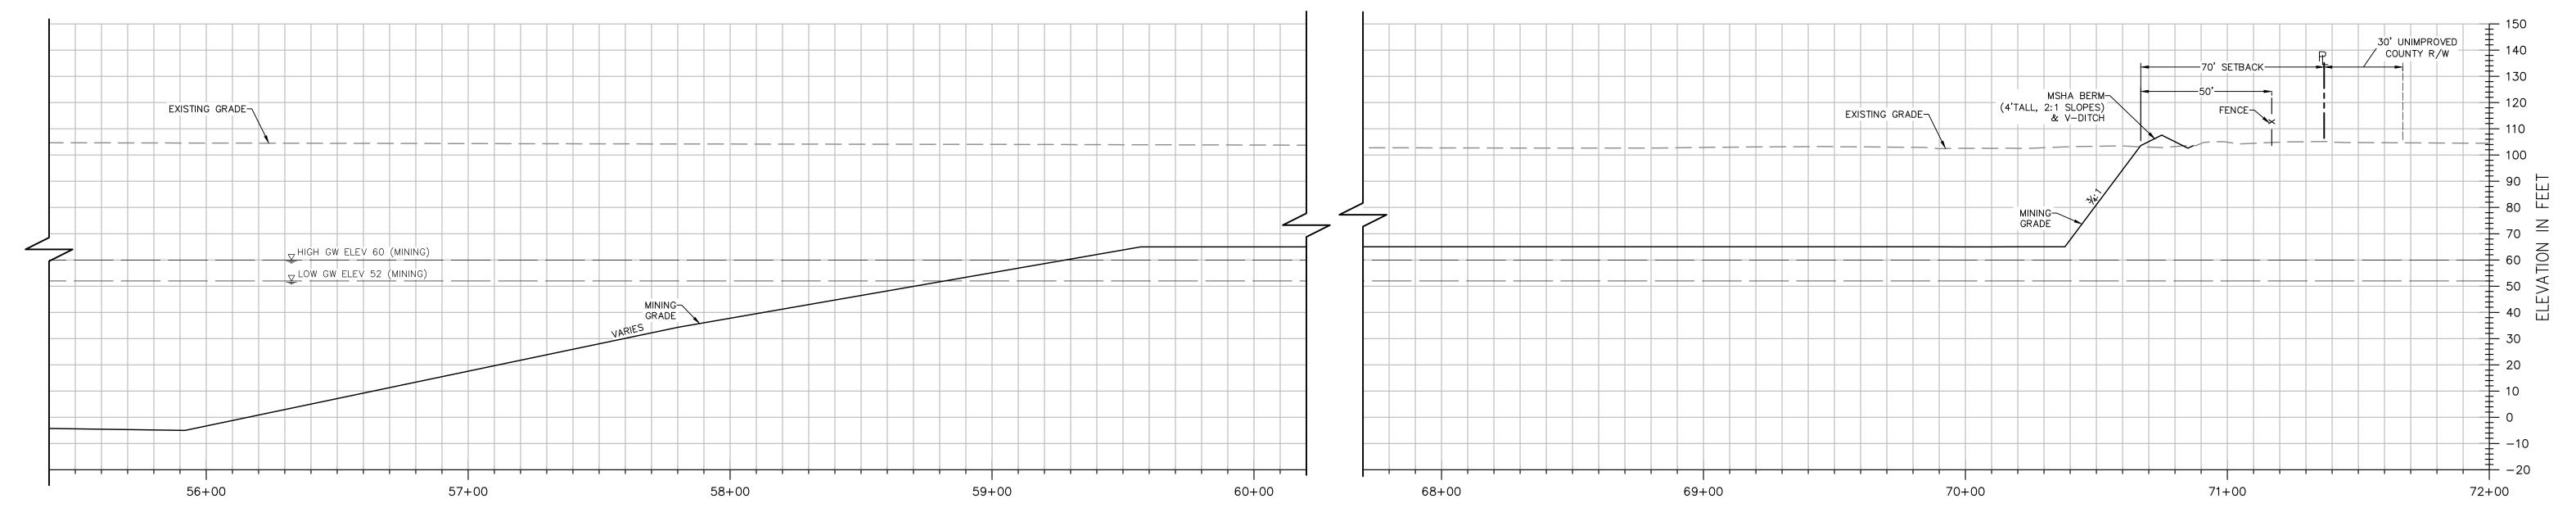

**SECTION F-F** 

### **NOTES:**


- 1. ELEVATIONS AND DISTANCES ARE APPROXIMATE. EXISTING GROUND IS BASED ON AERIAL TOPOGRAPHY FLOWN IN APRIL 2010 BY POINT CO. PHOTOGRAMMETRIC SERVICES.
- 2. HIGH AND LOW AVERAGE GROUNDWATER ELEVATIONS BASED ON "GROUNDWATER CONDITIONS IN THE VICINITY OF PLANNED WETPIT MINING OPERATIONS, SHIFFLER PROPERTY" AND "CONTOURS OF PREDICTED GROUNDWATER ELEVATION, AVERAGE FALL LOW, POST-RECLAMATION", BOTH BY LUHDORFF & SCALMANINI CONSULTING ENGINEERS DATED DECEMBER 22, 2015, UPDATED FEBRUARY 2016.
- 3. BERMS OR V—DITCHES TO BE ADDED ALONG THE TOP OF SLOPES AS NECESSARY TO KEEP SURFACE RUNOFF FROM ADJACENT AREAS FROM ENTERING INTO THE DESIGNATED OPEN WATER AREAS.
- 4. BOTTOM MINING ELEVATIONS ARE  $\pm 10^{\circ}$  DEPENDING ON ACTUAL BOTTOM OF GRAVEL DEPTHS.

SCALE 1" = 30'HOR. SCALE 1" = 30'VERT.



DESIGNED BY NC	NO.	DATE	REVISIONS	BY	APPD.
DRAWN BY NC/LR					
CHECKED BY SG					
SCALE					
AS SHOWN				·	
AS SHOWIN				·	



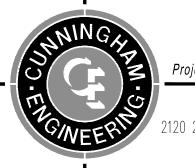

CECWEST.COM


(530) 758-2026 YOLO COUNTY


Project Planning ■ Civil Engineering ■ Landscape Architecture ■ Sacramento Office 2120 20th Street, Suite Three Sacramento, CA 95818 2940 Spafford Street, Suite 200 Davis, CA 95618

(916) 455-2026

SHIFLER MINING PLAN **CROSS SECTION F-F** 

**M-08** 9 DATE: 02/11/16

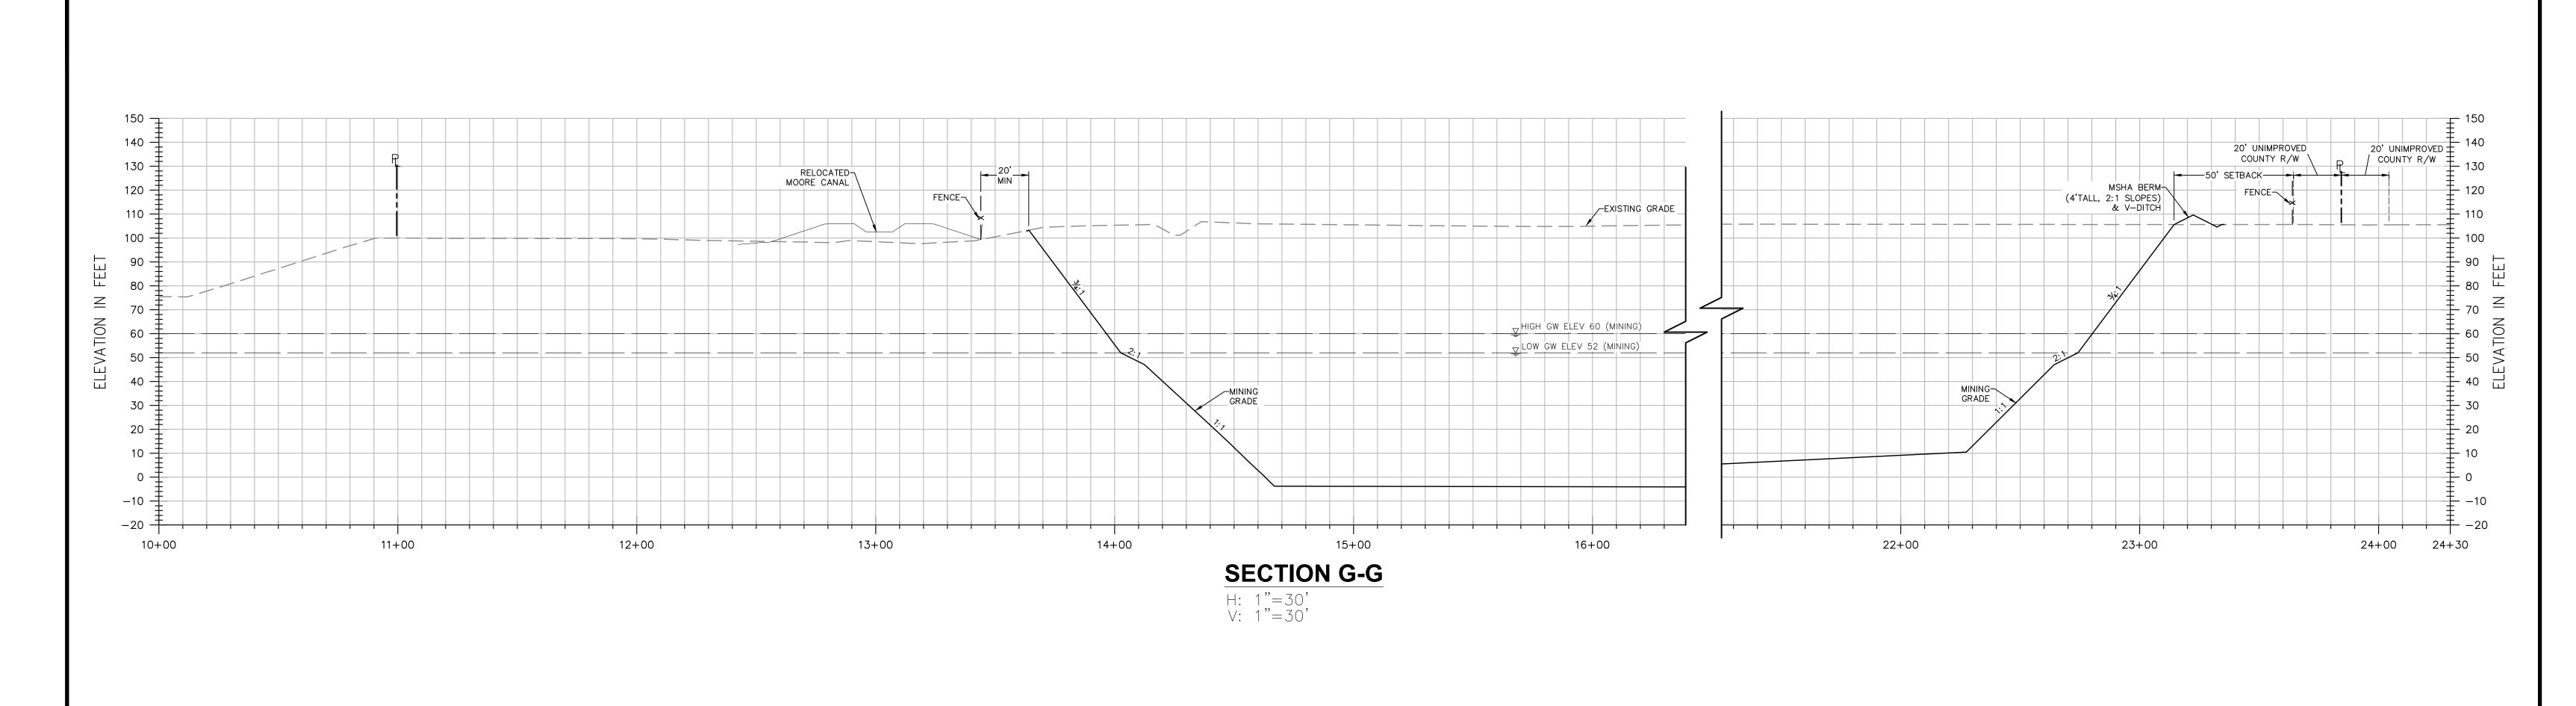

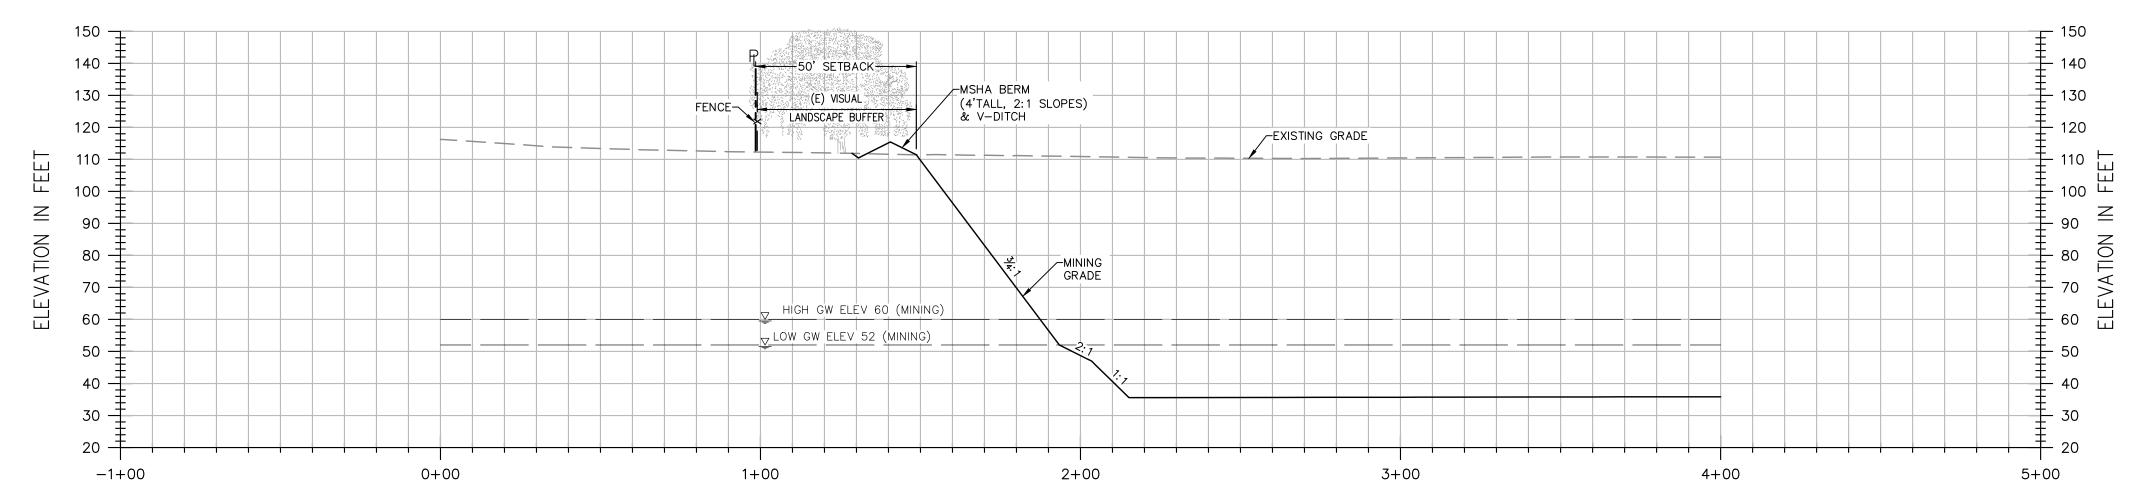

#### **SECTION H-H**

H: 1"=30' V: 1"=30'

### **NOTES:**

■ Davis Offic

- 1. ELEVATIONS AND DISTANCES ARE APPROXIMATE. EXISTING GROUND IS BASED ON AERIAL TOPOGRAPHY FLOWN IN APRIL 2010 BY POINT CO. PHOTOGRAMMETRIC SERVICES.
- 2. HIGH AND LOW AVERAGE GROUNDWATER ELEVATIONS BASED ON "GROUNDWATER CONDITIONS IN THE VICINITY OF PLANNED WETPIT MINING OPERATIONS, SHIFFLER PROPERTY" AND "CONTOURS OF PREDICTED GROUNDWATER ELEVATION, AVERAGE FALL LOW, POST-RECLAMATION", BOTH BY LUHDORFF & SCALMANINI CONSULTING ENGINEERS DATED DECEMBER 22, 2015, UPDATED FEBRUARY 2016.
- 3. BERMS OR V-DITCHES TO BE ADDED ALONG THE TOP OF SLOPES AS NECESSARY TO KEEP SURFACE RUNOFF FROM ADJACENT AREAS FROM ENTERING INTO THE DESIGNATED OPEN WATER AREAS.
- 4. BOTTOM MINING ELEVATIONS ARE  $\pm 10^{\circ}$  DEPENDING ON ACTUAL BOTTOM OF GRAVEL DEPTHS.


SCALE 1" = 30'HOR. SCALE 1" = 30'VERT.


**M-09** 

9



DESIGNED BY NC	NO.	DATE	REVISIONS	BY	APPD.	
						ĺ
DRAWN BYNC/LR_						
CHECKED BY SG						
SCALE						
AS SHOWN						
AS SHOWN						1
						•

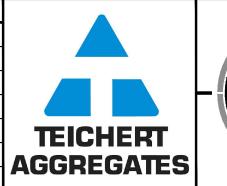

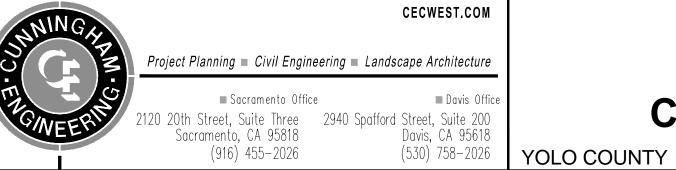

# SHIFLER MINING PLAN

**CROSS SECTION G-G & H-H** 

DATE: 02/11/16 CALIFORNIA JOB NO: 1129.20