CONCEPTUAL OFF-CHANNEL RECLAMATION PLAN

SHIFLER PROPERTY


GENERAL NOTES:


- 1. ALL WORK SHALL CONFORM TO THE YOLO COUNTY SURFACE MINING RECLAMATION ORDINANCE (ORD. #1191), THE PROJECT SPECIFIC CONDITIONS OF APPROVAL, THE PROJECT STÒRM WÄTER POLLUTION PREVENTION PLAN (SWPPP), THE SURFACE MINING AND RECLAMATION ACT (SMARA). OSHA, MSHA, AND OTHER APPLICABLE LOCAL, STATE AND FEDERAL REGULATIONS.
- EXISTING TOPOGRAPHY BASED ON AERIAL TOPOGRAPHY FLOWN IN APRIL 2010 BY POINT CO. PHOTOGRAMMETRIC SERVICES; VERIFY EXISTING CONDITIONS PRIOR TO
- ANY WORK THAT NEEDS TO BE PERFORMED WITHIN PG&E'S OR ANY OTHER UTILITY COMPANY'S EASEMENT WILL REQUIRE A CONSENT AGREEMENT FROM THE APPROPRIATE UTILITY COMPANY. USE CAUTION WHEN OPERATING ANY VEHICLES OR EQUIPMENT NEAR OVERHEAD AND UNDERGROUND ELECTRIC FACILITIES. COMPLY WITH ALL CONDITIONS LISTED IN THE CONSENT AGREEMENT.
- THE DEPTH OF MINING AND THE LIMIT-OF-MINING LINES ARE ONLY APPROXIMATE, AND ARE SUBJECT TO CHANGE BASED ON THE AMOUNT AND QUALITY OF MATERIAL UNCOVERED, AND THE ABILITY OF THE PRODUCER TO MEET THE RECLAMATION REQUIREMENTS. THE FORESEEABLE ESTIMATE OF VARIATION IS $\pm/-$ 10' IN MINING DEPTH; AND +/- 20% OF AREA FOR EACH TYPE OF RECLAMATION.
- HIGH AND LOW AVERAGE GROUNDWATER ELEVATIONS BASED ON "GROUNDWATER CONDITIONS IN THE VICINITY OF PLANNED WETPIT MINING OPERATIONS. SHIFFLER PROPERTY" AND "CONTOURS OF PREDICTED GROUNDWATER ELEVATION, AVERAGE FALL LOW, POST-RECLAMATION",, BY LUHDORFF & SCALMANINI CONSULTING ENGINEERS DATED DECEMBER 22, 2015, UPDATED FEBRUARY 2016.
- IF HUMAN SKELETAL REMAINS ARE ENCOUNTERED DURING EXCAVATION, ALL WORK WITHIN SEVENTY-FIVE (75) FEET SHALL IMMEDIATELY STOP, AND THE COUNTY CORONER SHALL BE NOTIFIED WITHIN TWENTY-FOUR (24) HOURS. IF ANY CULTURAL RESOURCES, SUCH AS CHIPPED OR GROUND STONE, HISTORIC DEBRIS, BUILDING FOUNDATIONS, OR PALEONTOLOGICAL MATERIALS ARE ENCOUNTERED DURING EXCAVATION, THEN ALL WORK WITHIN SEVENTY-FIVE (75) FEET SHALL IMMEDIATELY STOP AND THE DIRECTOR SHALL BE NOTIFIED AT ONCE. ANY CULTURAL RESOURCES FOUND ON THE SITE SHALL BE RECORDED BY A QUALIFIED ARCHAEOLOGIST AND THE INFORMATION SHALL BE SUBMITTED TO THE COUNTY.
- DURING OPERATIONS, THE SITE SHALL BE KEPT FREE OF DEBRIS AND MAINTAINED IN A NEAT AND ORDERLY MANNER SO AS NOT TO CREATE ANY HAZARDOUS OR UNSIGHTLY CONDITIONS. OVERBURDEN SHALL BE STOCKPILED AND STUMPS, BRUSH, OR OTHER DEBRIS RESULTING FROM EXCAVATION AND/OR PROCESSING SHALL BE
- UNNECESSARY PERSONNEL SHALL BE EXCLUDED FROM OFF-CHANNEL EXCAVATIONS. OPEN PITS SHALL BE FENCED WITH A FOUR STRAND BARBED WIRE FENCE OR THE EQUIVALENT, PRIOR TO THE COMMENCEMENT OF EXCAVATION. FENCING MAY ENCLOSE THE PROPERTY OF WHICH THE MINING SITE IS A PART, THE MINING SITE, OR BOTH. IN ADDITION, SIGNS SHALL BE INSTALLED AT THE PROJECT SITE BOUNDARIES AND ACCESS ROAD, INDICATING THAT THE EXCAVATION AREA IS A DANGER ZONE.

ABBREVIATIONS:


AC	ACRES	IRR	IRRIGATION
AG	AGRICULTURAL	MSHA	MINE SAFETY AND HEALTH ADMINISTRATION
AGG	AGGREGATE	MW	MONITOR WELL
AMSL	ABOVE MEAN SEA LEVEL	N	NORTH
APN	ASSESSOR'S PARCEL NUMBER	N.I.C.	NOT IN CONTRACT
AVG	AVERAGE	OG	ORIGINAL GROUND ELEVATION
CFR	CODE OF FEDERAL REGULATIONS	OSHA	OCCUPATIONAL SAFETY AND HEALTH ADMINISTRATION
CL	CENTER LINE	PL	PROPERTY LINE
CY	CUBIC YARDS	R	RADIUS
Е	EAST	R/W	RIGHT-OF-WAY
ELEV	ELEVATION	RECL.	RECLAMATION
FG	FINISH GRADE	S	SLOPE
FL	FLOW LINE	S&G	SAND AND GRAVEL
FT	FEET	TYP	TYPICAL
GB	GRADE BREAK	V	VERTICAL
GW	GROUND WATER	W	WEST
Н	HORIZONTAL	YR	YEAR


LEGEND:

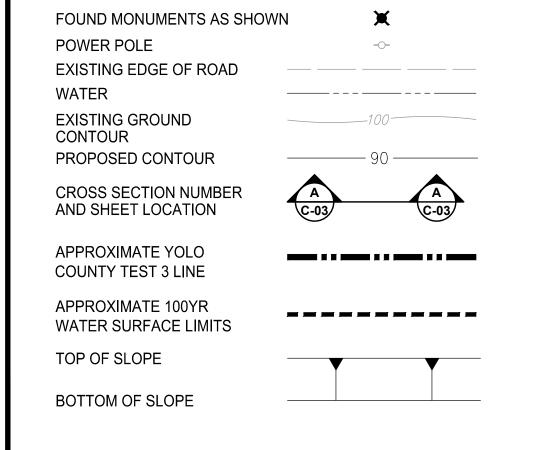

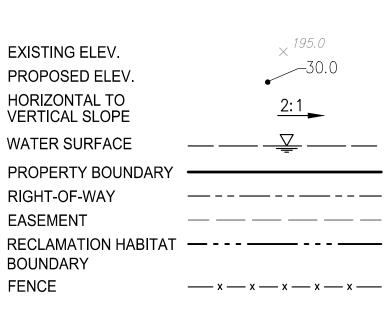

YOLO COUNTY, CALIFORNIA FEBRUARY 2016

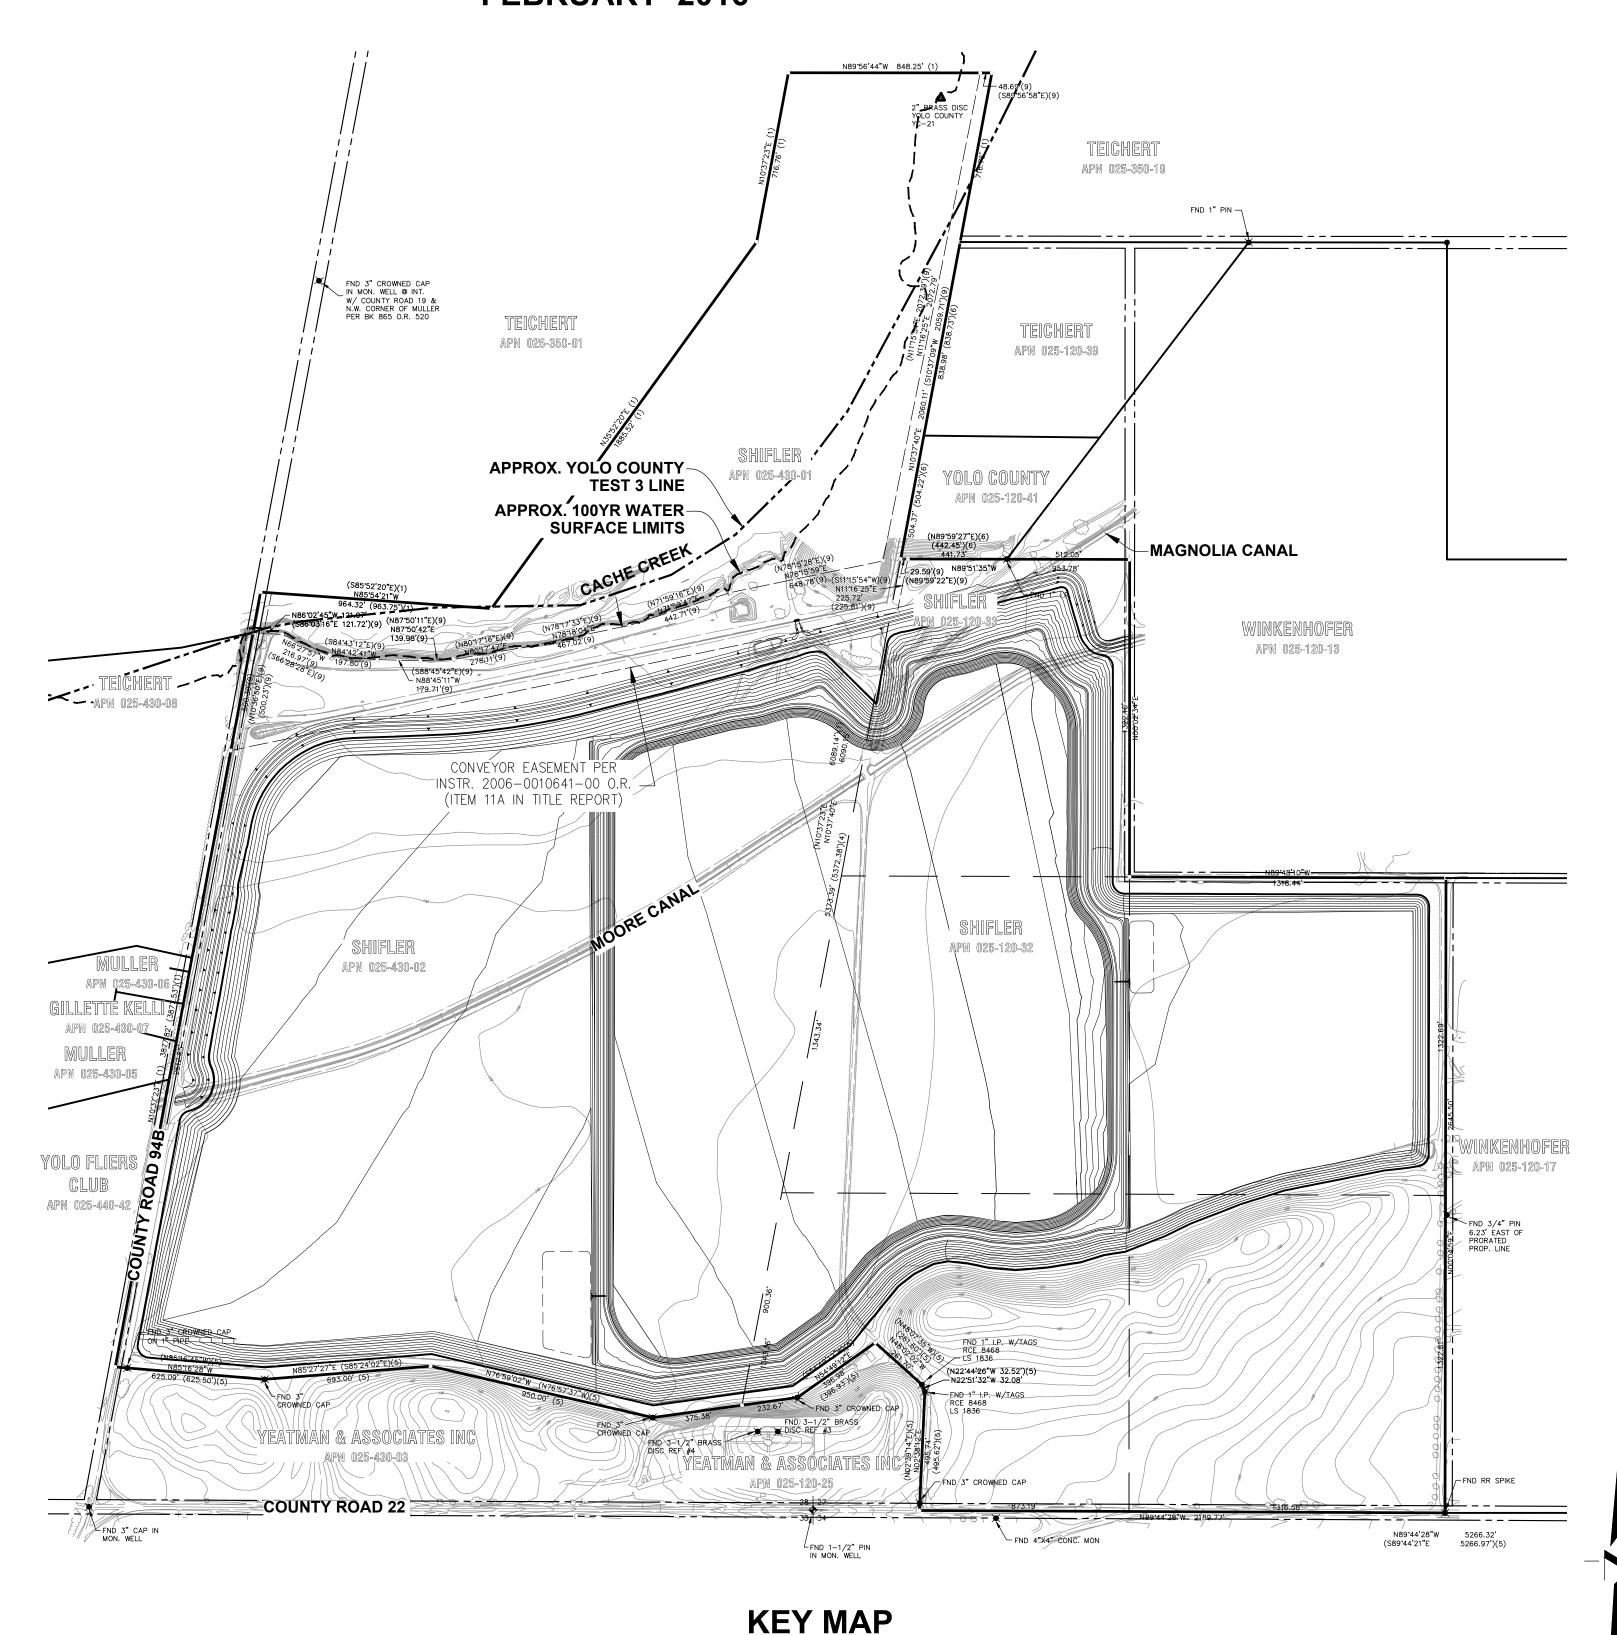

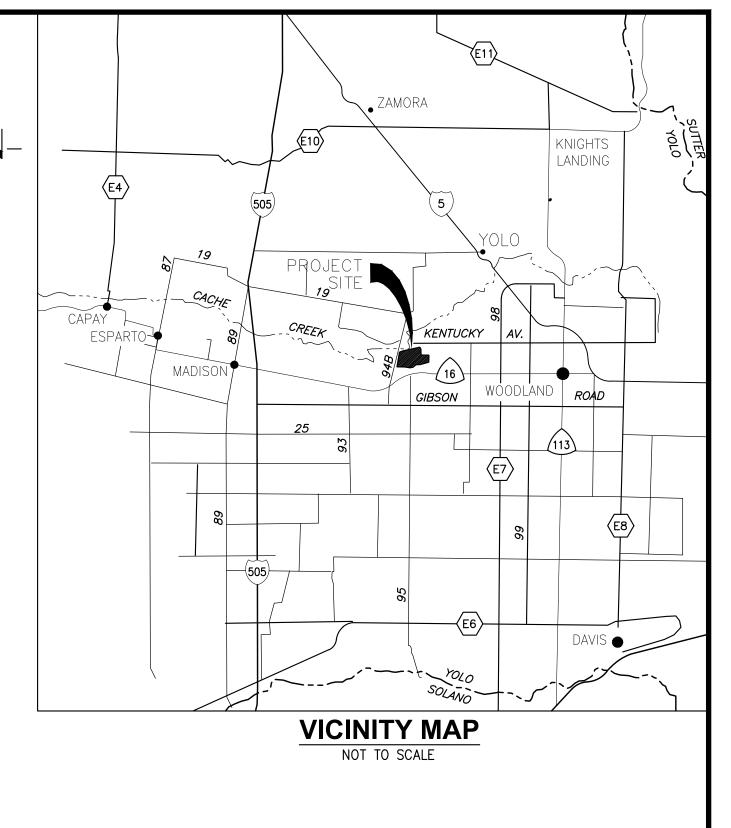

SHEET INDEX:

R-01 TITLE SHEET

R-02 SITE PLAN

R-03 CROSS SECTION A-A

R-04 CROSS SECTION B-B

R-05 CROSS SECTION C-C

R-06 CROSS SECTION D-D

R-07 CROSS SECTION E-E

R-08 CROSS SECTION F-F

R-09 CROSS SECTION G-G & H-H

BENCHMARK:

EXISTING TOPOGRAPHY BASED ON AERIAL TOPOGRAPHY FLOWN IN APRIL 2010 BY POINT CO. PHOTOGRAMMETRIC SERVICES. AERIAL TARGETS SURVEYED BY LAUGENOUR AND MEIKLE, WOODLAND. **HORIZONTAL DATUM: CA NAD83 ZONE 2 VERTICAL DATUM: NAVD 88**

ASSESSORS PARCEL NO:

025-120-32 025-120-33 025-430-02 025-430-01

PROPERTY OWNER:

SHIFLER LJ FAMILY TRUST INC. **35030 COUNTY ROAD 20** WOODLAND, CA 95851

APPLICANT:

TEICHERT AGGREGATES P.O. BOX 15002 SACRAMENTO, CA 95851 (916) 484-3319

CIVIL ENGINEER:

CUNNINGHAM ENGINEERING 2940 SPAFFORD STREET, SUITE 200 DAVIS, CALIFORNIA 95618 (530) 758-2026


DRAWING STATUS:

PLAN REVIEW SET — NOT FOR CONSTRUCTION

O PERMIT SET



,					
DESIGNED BY NC	NO.	DATE	REVISIONS	BY	APPD.
DRAWN BYNC/LR_					
CHECKED BY SG					
SCALE					
AS SHOWN					
AS SHOWN					

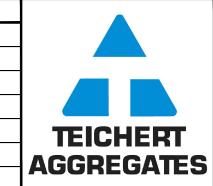

1"=400'



CECWEST.COM

YOLO COUNTY

Davis, CA 95618


(530) 758-2026


SHIFLER RECLAMATION PLAN


TITLE SHEET

R-01 9

DATE: _ 02/08/16 CALIFORNIA JOB NO: 1129.20

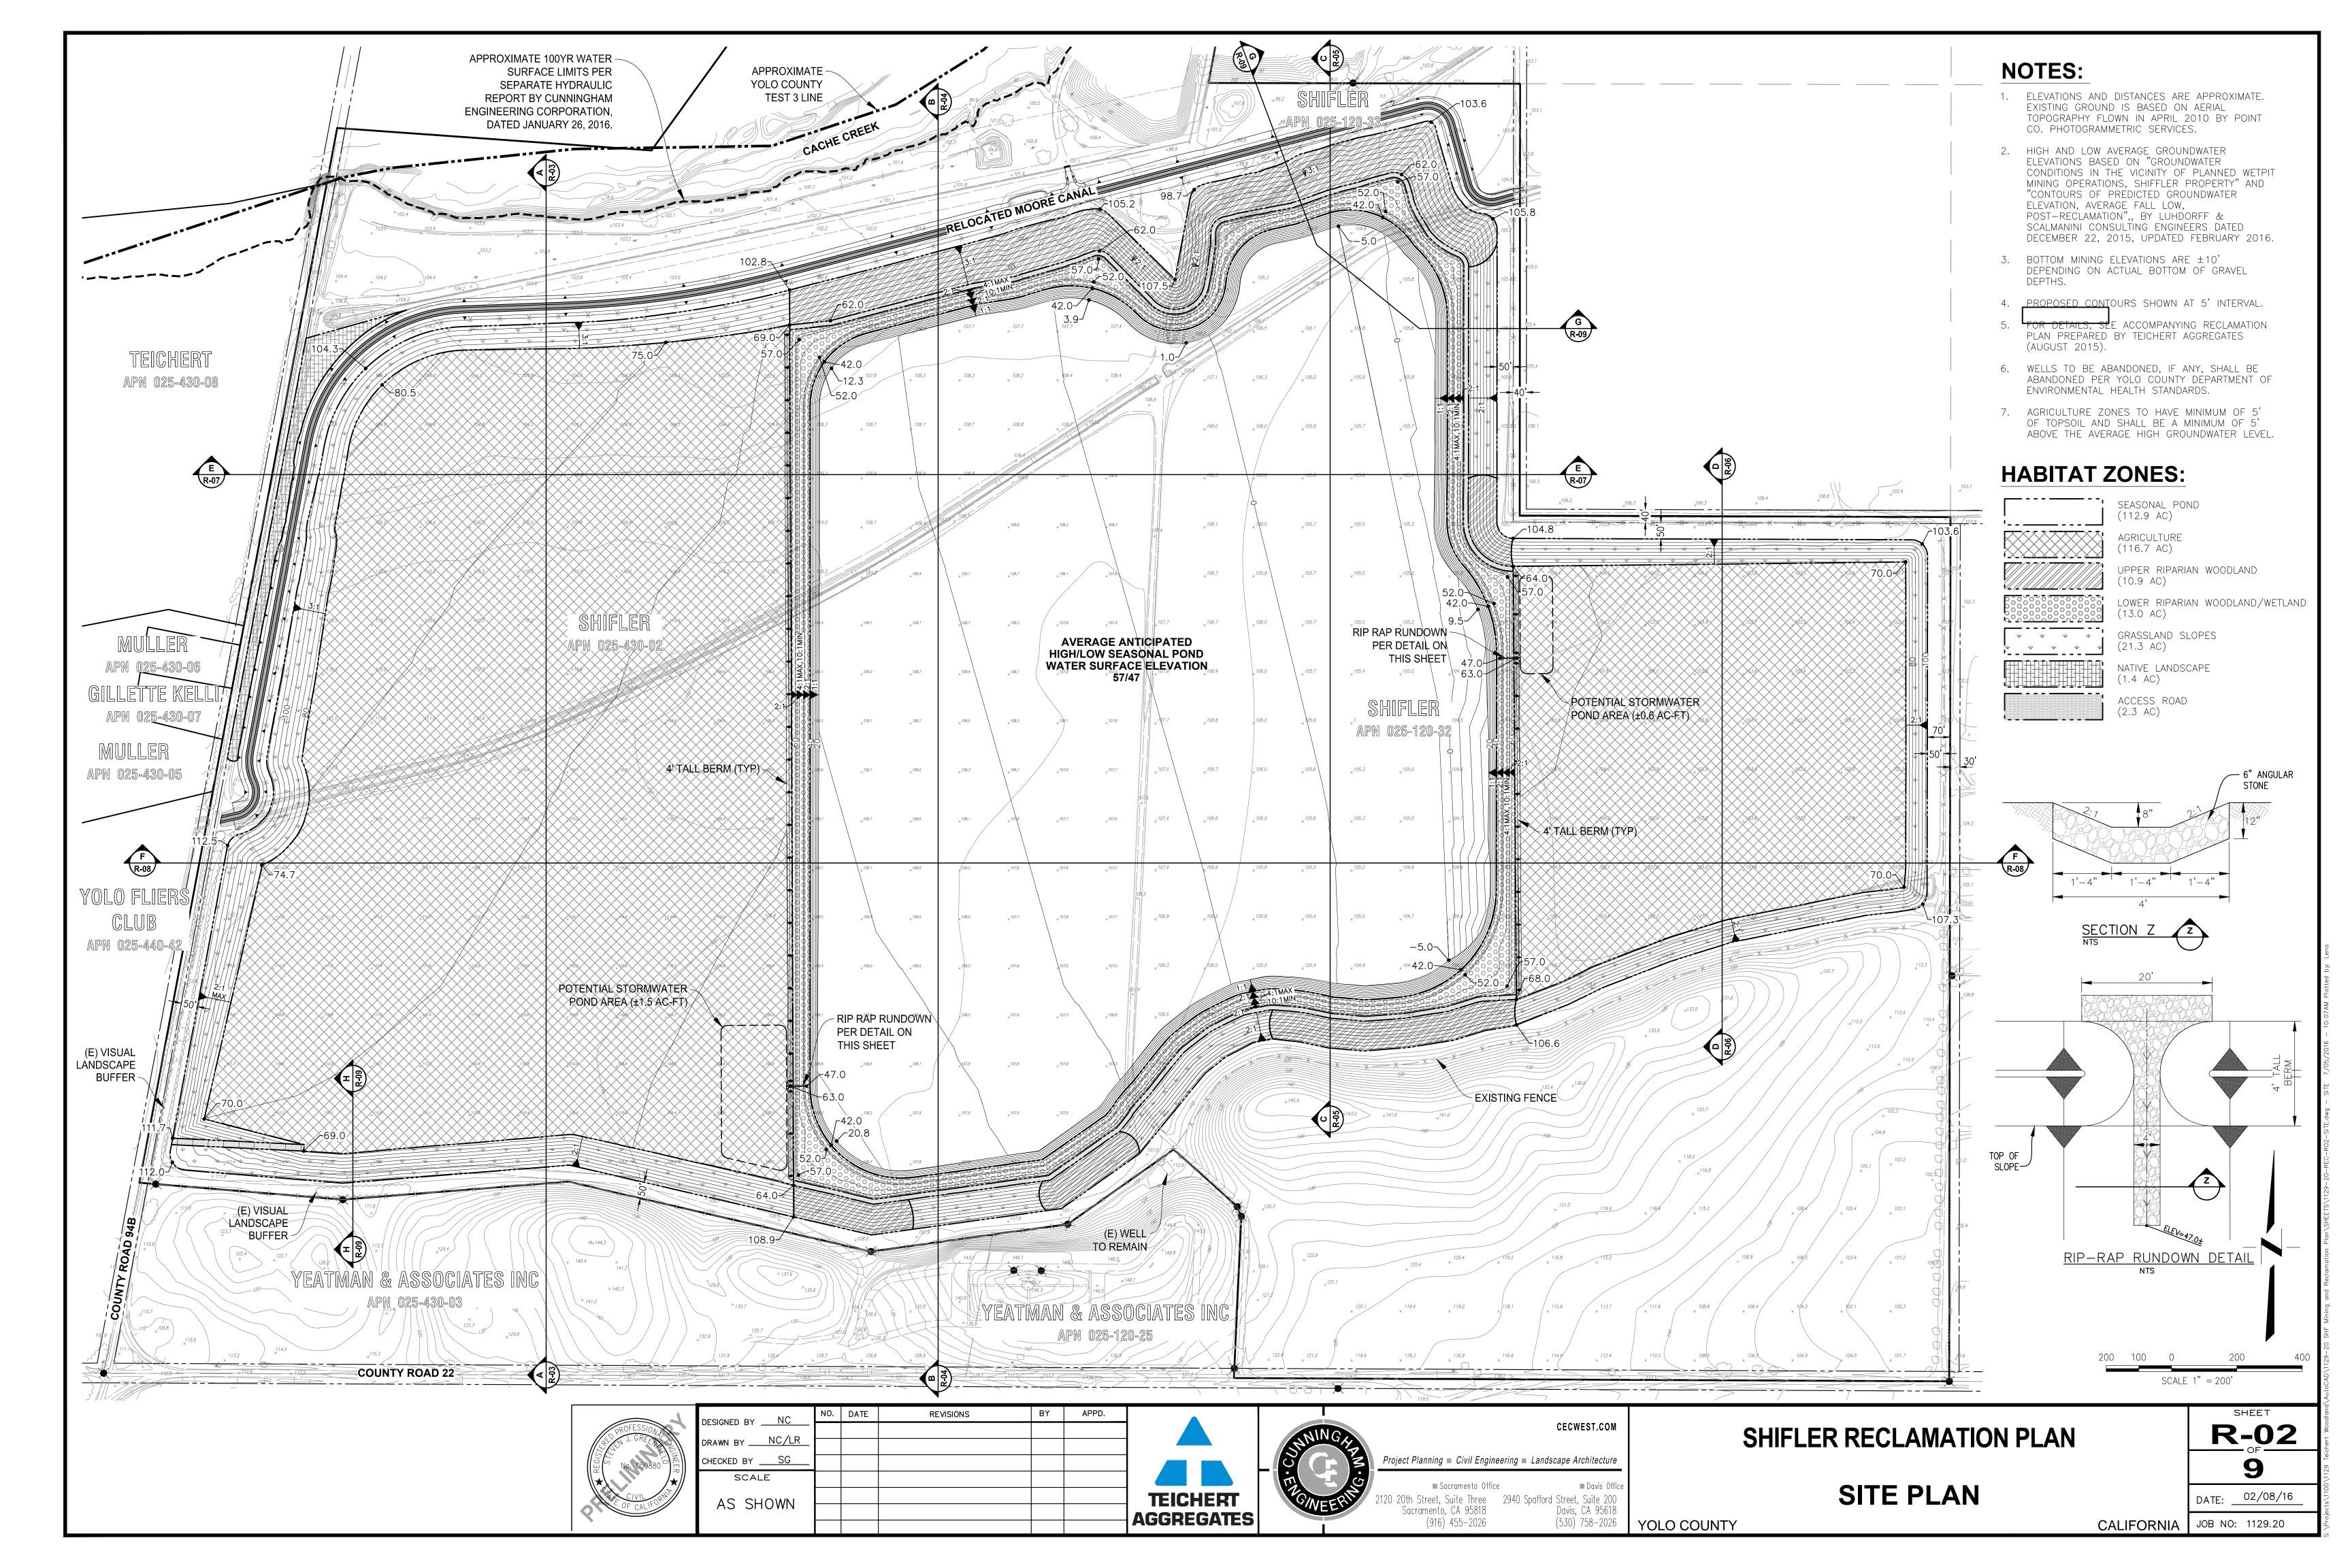

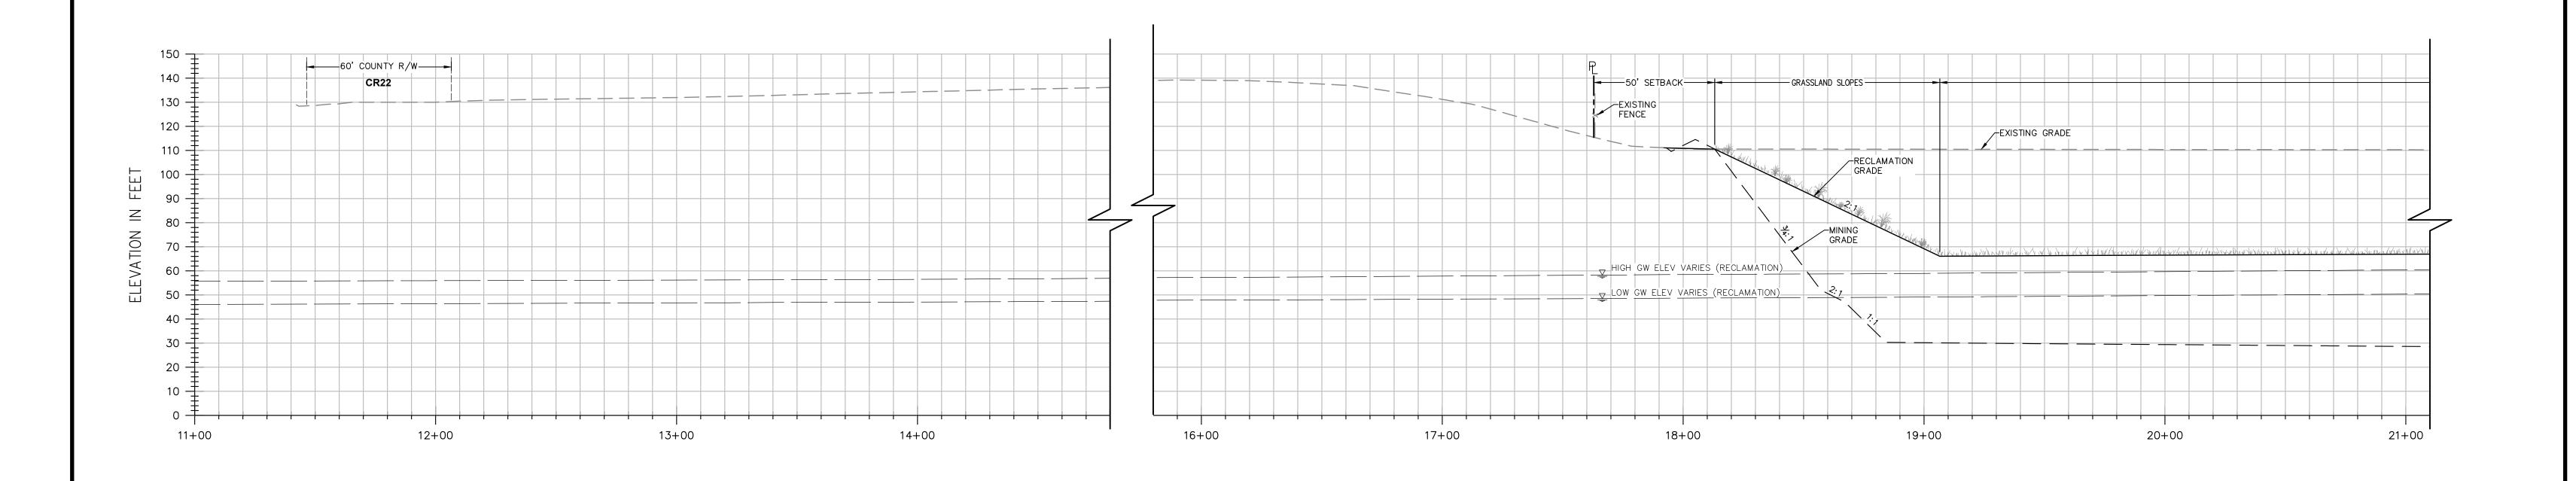

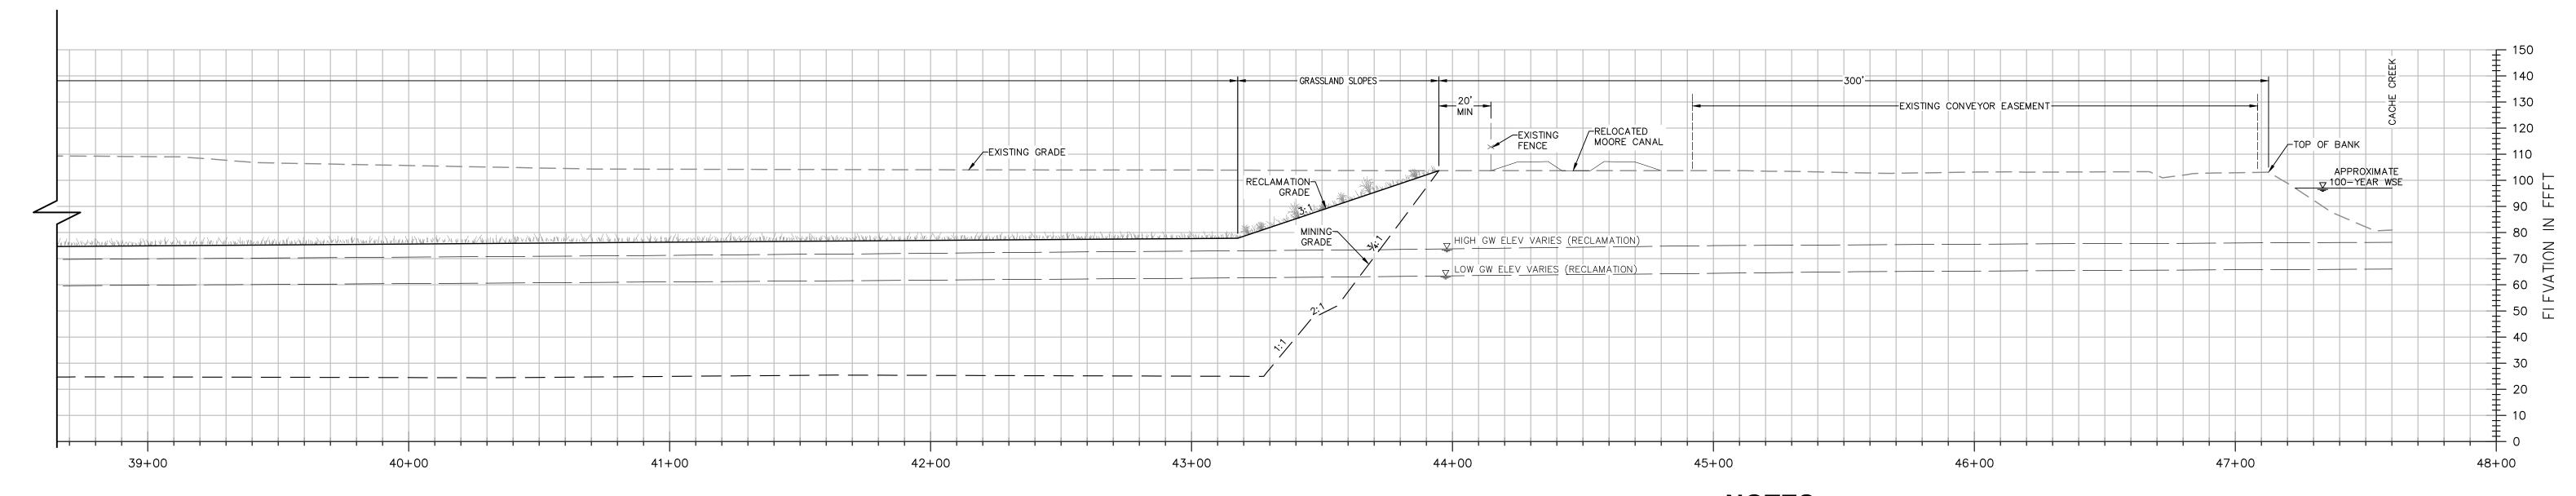

SECTION A-A


NOTES:


- 1. ELEVATIONS AND DISTANCES ARE APPROXIMATE. EXISTING GROUND IS BASED ON AERIAL TOPOGRAPHY FLOWN IN APRIL 2010 BY POINT CO. PHOTOGRAMMETRIC SERVICES.
- 2. HIGH AND LOW AVERAGE GROUNDWATER ELEVATIONS BASED ON "GROUNDWATER CONDITIONS IN THE VICINITY OF PLANNED WETPIT MINING OPERATIONS, SHIFFLER PROPERTY" AND "CONTOURS OF PREDICTED GROUNDWATER ELEVATION, AVERAGE FALL LOW, POST-RECLAMATION", BOTH BY LUHDORFF & SCALMANINI CONSULTING ENGINEERS DATED DECEMBER 22, 2015, UPDATED FEBRUARY 2016.
- 3. BERMS OR V—DITCHES TO BE ADDED ALONG THE TOP OF SLOPES AS NECESSARY TO KEEP SURFACE RUNOFF FROM ADJACENT AREAS FROM ENTERING INTO THE DESIGNATED OPEN WATER
- 4. BOTTOM MINING ELEVATIONS ARE $\pm 10^{\circ}$ DEPENDING ON ACTUAL BOTTOM OF GRAVEL DEPTHS.
- 5. AGRICULTURE ZONES TO HAVE MINIMUM OF 5' OF TOPSOIL AND SHALL BE A MINIMUM OF 5' ABOVE THE AVERAGE HIGH GROUNDWATER LEVEL.

SCALE 1" = 30'HOR. SCALE 1" = 30'VERT.



DESIGNED BY NC	NO.	DATE	REVISIONS	BY	APPD.	
DRAWN BYNC/LR_						
CHECKED BY SG						
SCALE						
AS SHOWN						
AS SHOWN						
						1

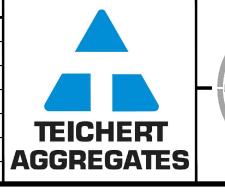

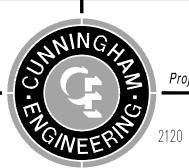

CECWEST.COM

(530) 758-2026 YOLO COUNTY

Project Planning ■ Civil Engineering ■ Landscape Architecture ■ Sacramento Office 120 20th Street, Suite Three 2940 Spafford Street, Suite 200 Sacramento, CA 95818 Davis, CA 95618


(916) 455-2026


SHIFLER RECLAMATION PLAN

CROSS SECTION A-A


R-03 9

DATE: 02/08/16 CALIFORNIA JOB NO: 1129.20

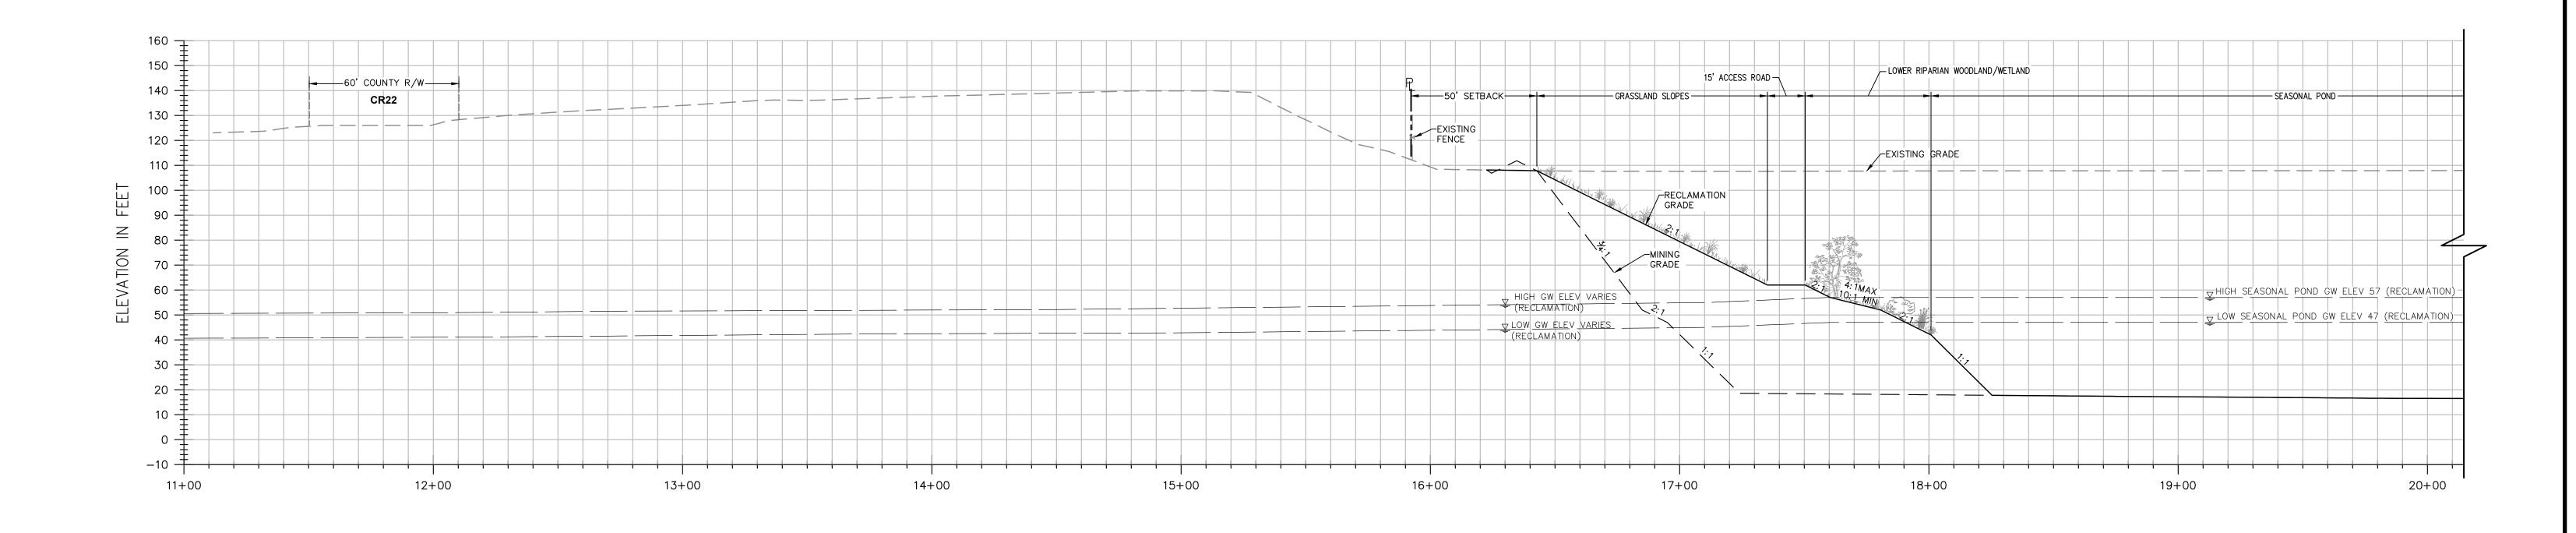

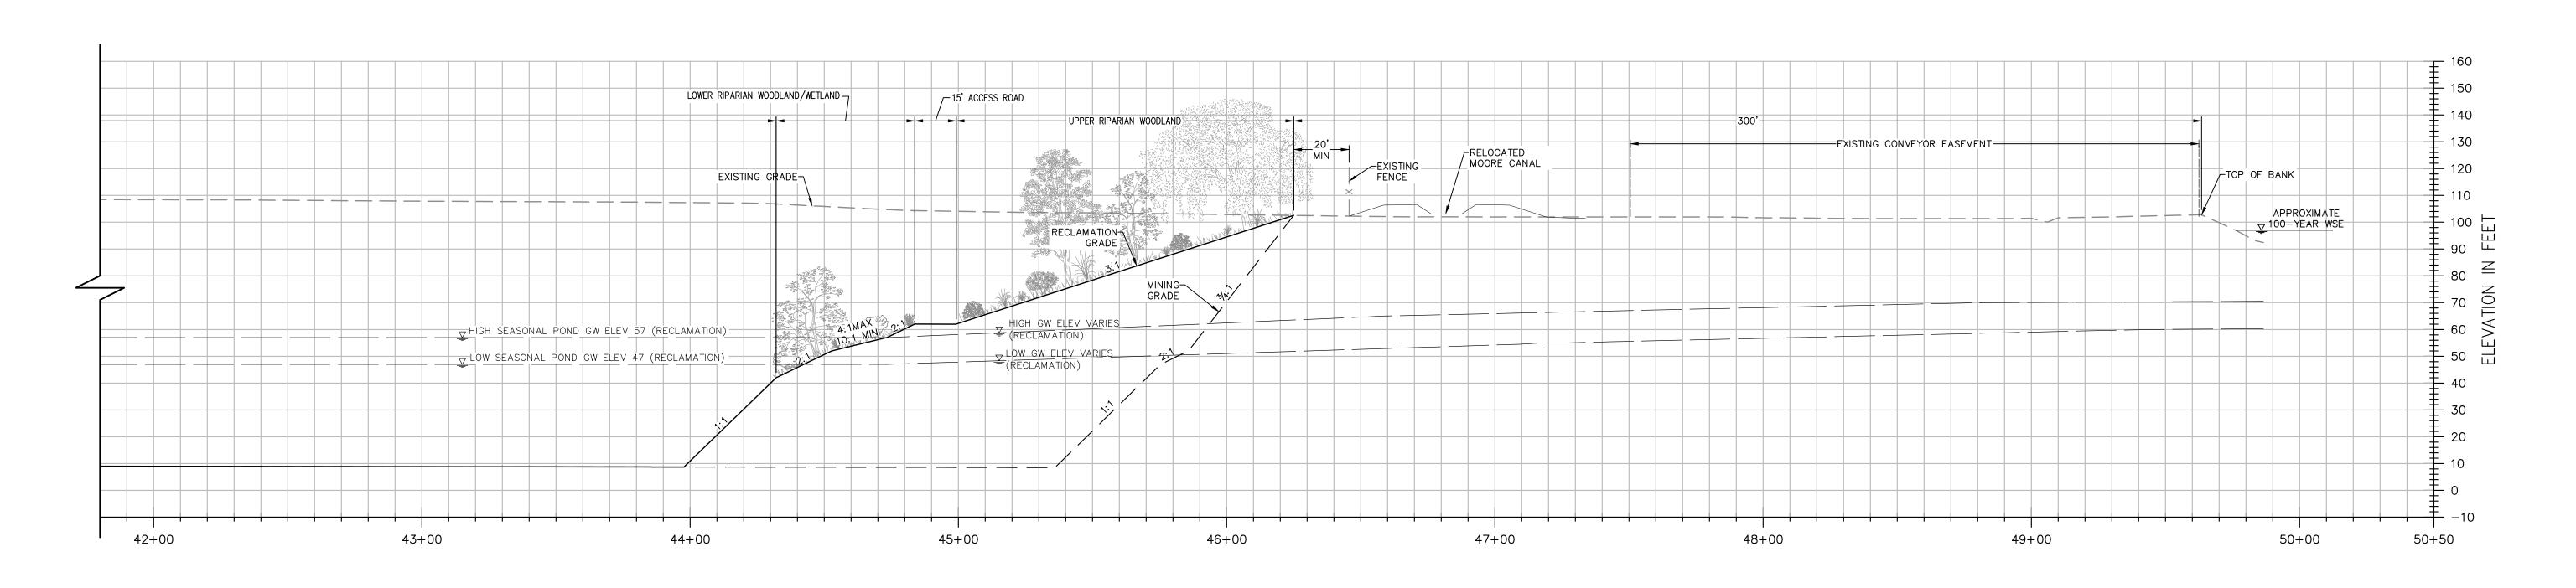

SECTION B-B

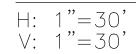

NOTES:

- 1. ELEVATIONS AND DISTANCES ARE APPROXIMATE. EXISTING GROUND IS BASED ON AERIAL TOPOGRAPHY FLOWN IN APRIL 2010 BY POINT CO. PHOTOGRAMMETRIC SERVICES.
- 2. HIGH AND LOW AVERAGE GROUNDWATER ELEVATIONS BASED ON "GROUNDWATER CONDITIONS IN THE VICINITY OF PLANNED WETPIT MINING OPERATIONS, SHIFFLER PROPERTY" AND "CONTOURS OF PREDICTED GROUNDWATER ELEVATION, AVERAGE FALL LOW, POST—RECLAMATION", BOTH BY LUHDORFF & SCALMANINI CONSULTING ENGINEERS DATED DECEMBER 22, 2015, UPDATED
- 3. BERMS OR V—DITCHES TO BE ADDED ALONG THE TOP OF SLOPES AS NECESSARY TO KEEP SURFACE RUNOFF FROM ADJACENT AREAS FROM ENTERING INTO THE DESIGNATED OPEN WATER
- 4. BOTTOM MINING ELEVATIONS ARE ± 10 ' DEPENDING ON ACTUAL BOTTOM OF GRAVEL DEPTHS.
- 5. AGRICULTURE ZONES TO HAVE MINIMUM OF 5' OF TOPSOIL AND SHALL BE A MINIMUM OF 5' ABOVE THE AVERAGE HIGH GROUNDWATER LEVEL.

SCALE 1" = 30'HOR. SCALE 1" = 30'VERT.



SIGNED BY NC	NO.	DATE	REVISIONS	BY	APPD.	
AWN BYNC/LR_						
ECKED BY SG						
SCALE						
AS SHOWN						
AS SHOWN						l,
						4





CECWEST.COM

(530) 758-2026 YOLO COUNTY

Project Planning ■ Civil Engineering ■ Landscape Architecture ■ Sacramento Office 120 20th Street, Suite Three 2940 Spafford Street, Suite 200 Sacramento, CA 95818 Davis, CA 95618


(916) 455-2026


SHIFLER RECLAMATION PLAN

CROSS SECTION B-B

9 DATE: 02/08/16

R-04

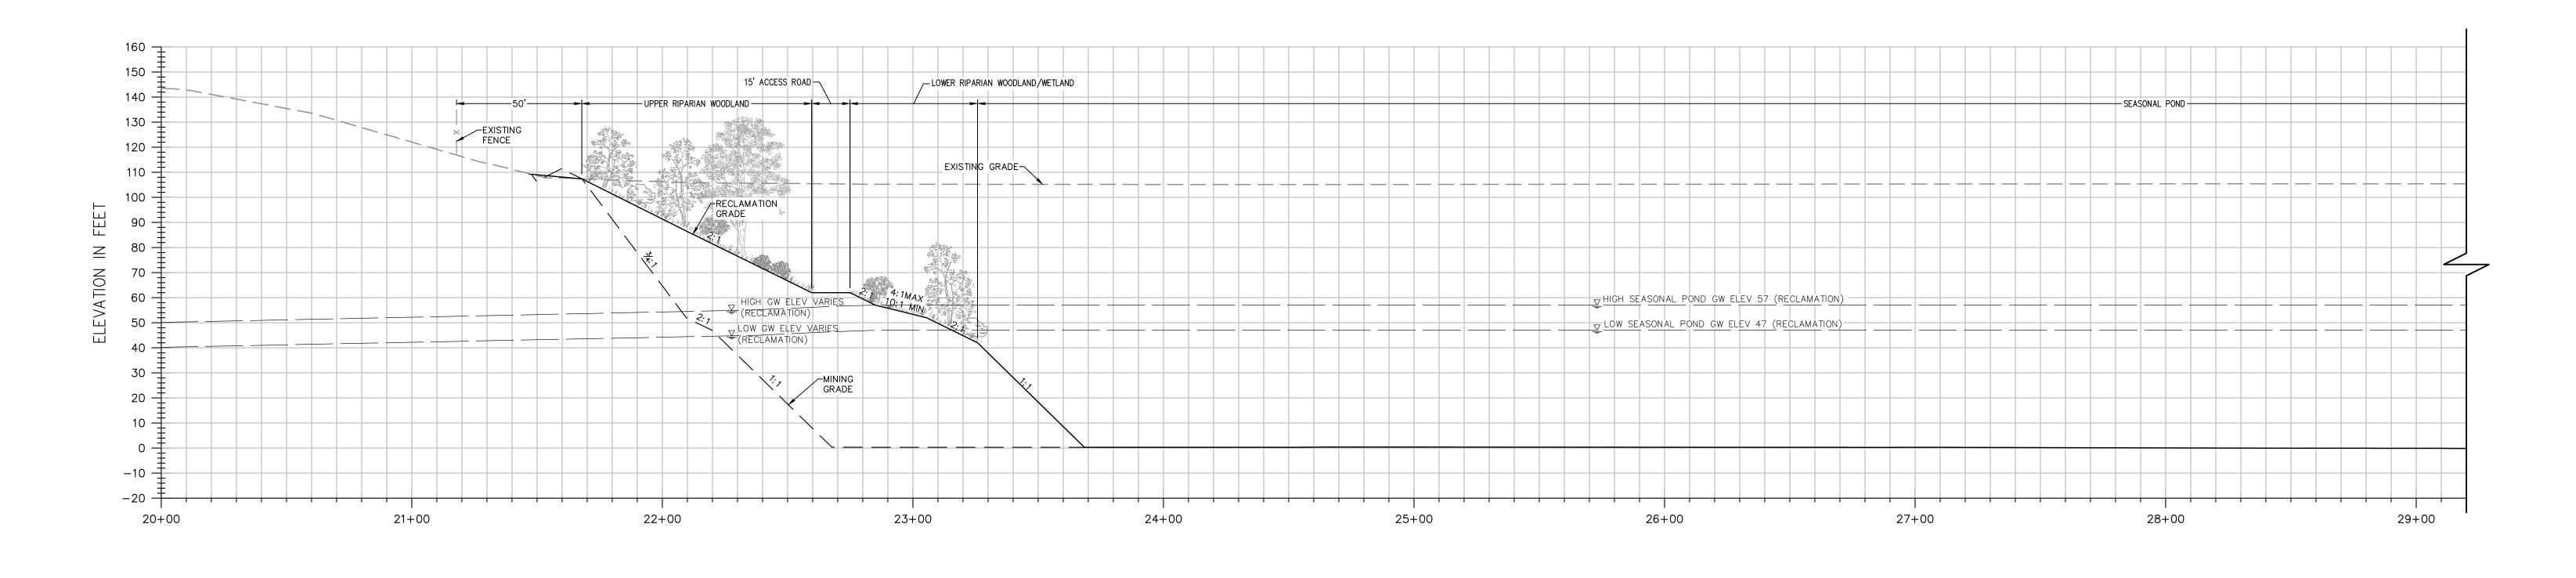

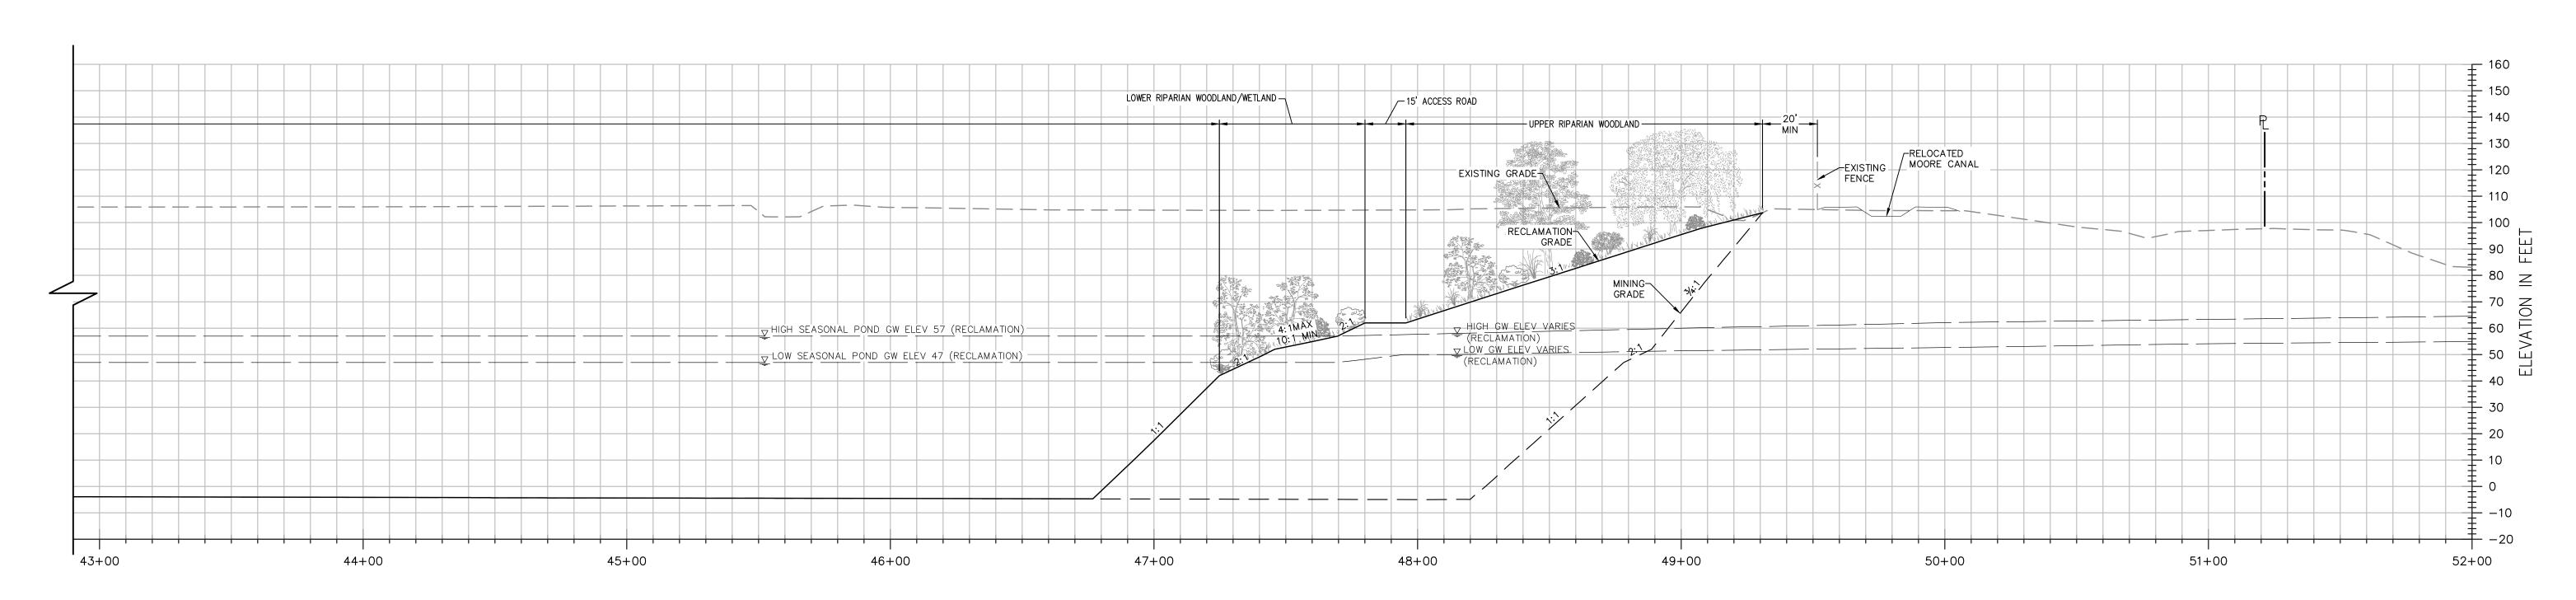

SECTION C-C


NOTES:


- 1. ELEVATIONS AND DISTANCES ARE APPROXIMATE. EXISTING GROUND IS BASED ON AERIAL TOPOGRAPHY FLOWN IN APRIL 2010 BY POINT CO. PHOTOGRAMMETRIC SERVICES.
- 2. HIGH AND LOW AVERAGE GROUNDWATER ELEVATIONS BASED ON "GROUNDWATER CONDITIONS IN THE VICINITY OF PLANNED WETPIT MINING OPERATIONS, SHIFFLER PROPERTY" AND "CONTOURS OF PREDICTED GROUNDWATER ELEVATION, AVERAGE FALL LOW, POST-RECLAMATION", BOTH BY LUHDORFF & SCALMANINI CONSULTING ENGINEERS DATED DECEMBER 22, 2015, UPDATED
- 3. BERMS OR V—DITCHES TO BE ADDED ALONG THE TOP OF SLOPES AS NECESSARY TO KEEP SURFACE RUNOFF FROM ADJACENT AREAS FROM ENTERING INTO THE DESIGNATED OPEN WATER AREAS.
- 4. BOTTOM MINING ELEVATIONS ARE $\pm 10^{\circ}$ DEPENDING ON ACTUAL BOTTOM OF GRAVEL DEPTHS.
- 5. AGRICULTURE ZONES TO HAVE MINIMUM OF 5' OF TOPSOIL AND SHALL BE A MINIMUM OF 5' ABOVE THE AVERAGE HIGH GROUNDWATER LEVEL.

SCALE 1" = 30'HOR. SCALE 1" = 30'VERT.



DESIGNED BY NC	NO.	DATE	REVISIONS	BY	APPD.	
DRAWN BYNC/LR_						
CHECKED BY SG						
SCALE						
AS SHOWN						
713 3110 1111						1
						_

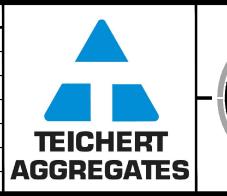

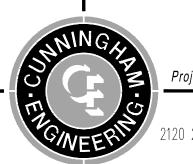

CECWEST.COM


Project Planning ■ Civil Engineering ■ Landscape Architecture ■ Sacramento Office 120 20th Street, Suite Three 2940 Spafford Street, Suite 200 Sacramento, CA 95818 Davis, CA 95618 (530) 758-2026 YOLO COUNTY


(916) 455-2026

SHIFLER RECLAMATION PLAN

CROSS SECTION C-C

R-05 9 DATE: 02/08/16

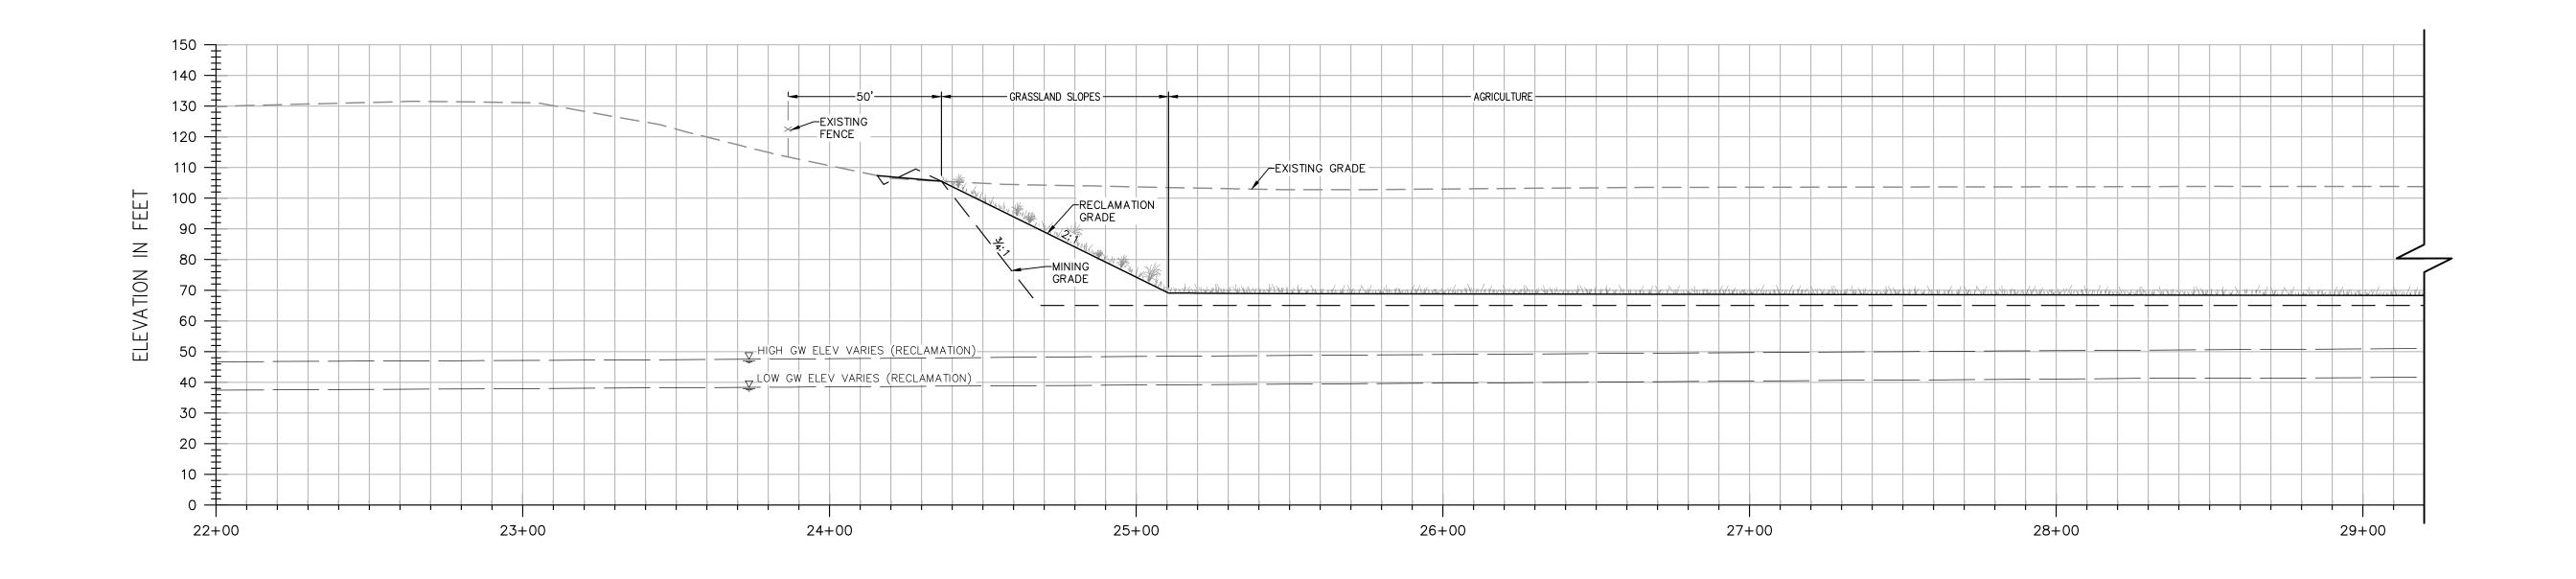

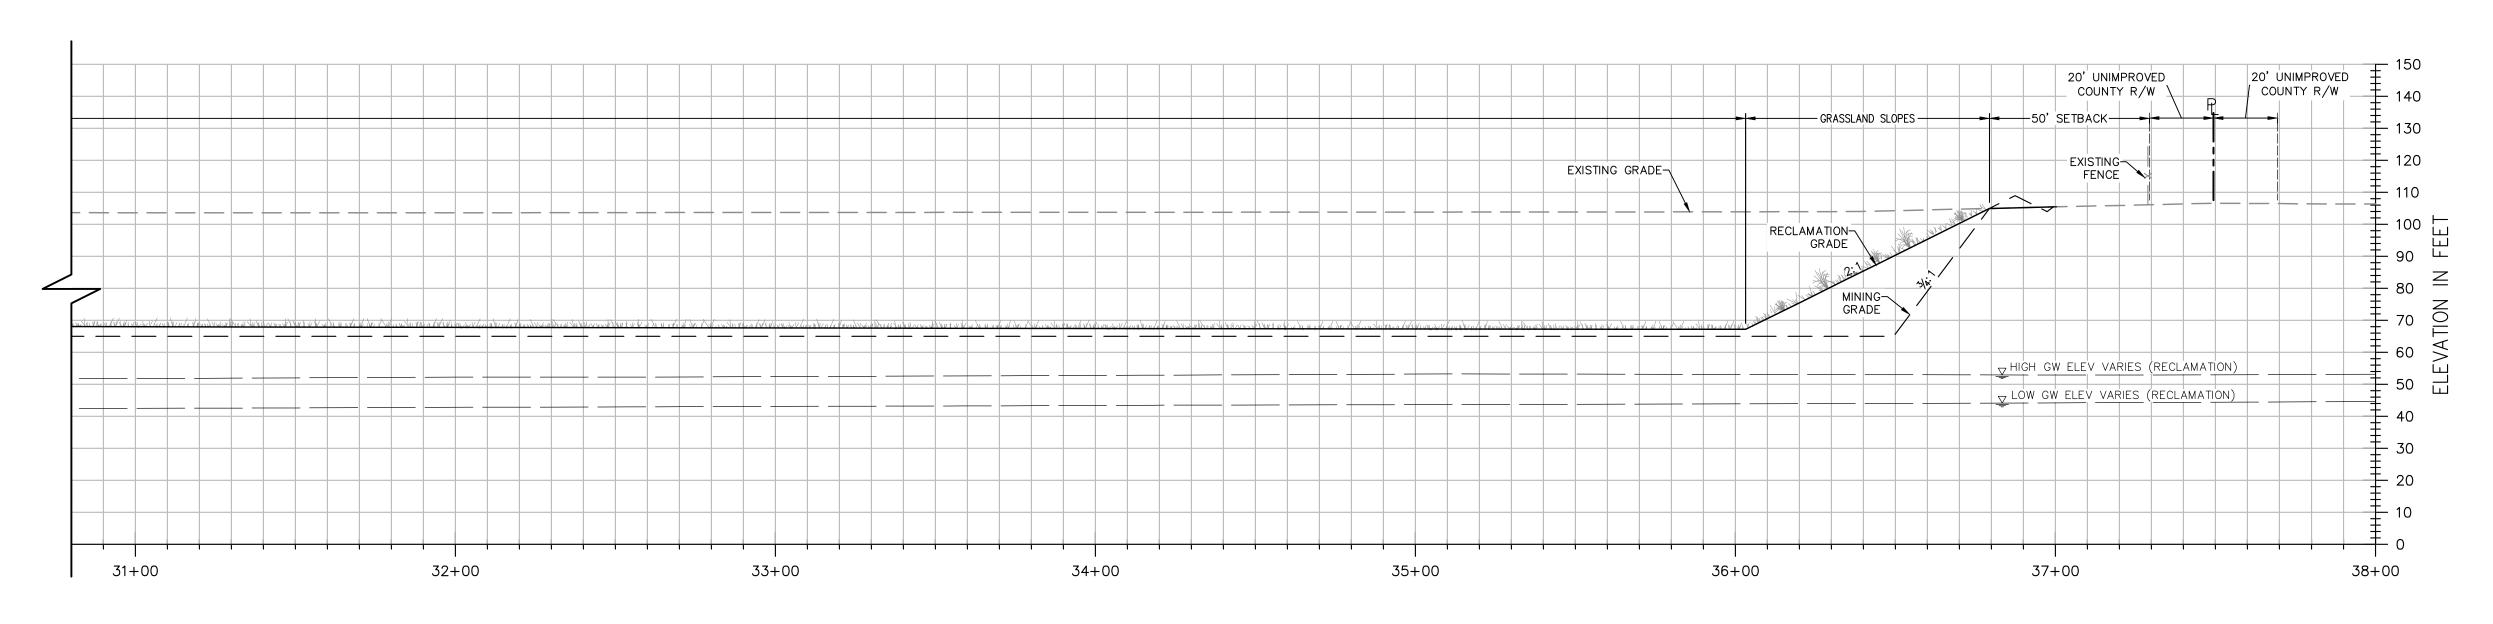

SECTION D-D


NOTES:

- 1. ELEVATIONS AND DISTANCES ARE APPROXIMATE. EXISTING GROUND IS BASED ON AERIAL TOPOGRAPHY FLOWN IN APRIL 2010 BY POINT CO. PHOTOGRAMMETRIC SERVICES.
- 2. HIGH AND LOW AVERAGE GROUNDWATER ELEVATIONS BASED ON "GROUNDWATER CONDITIONS IN THE VICINITY OF PLANNED WETPIT MINING OPERATIONS, SHIFFLER PROPERTY" AND "CONTOURS OF PREDICTED GROUNDWATER ELEVATION, AVERAGE FALL LOW, POST—RECLAMATION", BOTH BY LUHDORFF & SCALMANINI CONSULTING ENGINEERS DATED DECEMBER 22, 2015, UPDATED FEBRUARY 2016.
- 3. BERMS OR V-DITCHES TO BE ADDED ALONG THE TOP OF SLOPES AS NECESSARY TO KEEP SURFACE RUNOFF FROM ADJACENT AREAS FROM ENTERING INTO THE DESIGNATED OPEN WATER AREAS.
- 4. BOTTOM MINING ELEVATIONS ARE $\pm 10^{\circ}$ DEPENDING ON ACTUAL BOTTOM OF GRAVEL DEPTHS.
- 5. AGRICULTURE ZONES TO HAVE MINIMUM OF 5' OF TOPSOIL AND SHALL BE A MINIMUM OF 5' ABOVE THE AVERAGE HIGH GROUNDWATER LEVEL.

SCALE 1" = 30'HOR. SCALE 1" = 30'VERT.



DESIGNED BY NC	NO.	DATE	REVISIONS	BY	APPD.	
DRAWN BYNC/LR_						
CHECKED BY SG						
SCALE						
AS SHOWN						
AS SHOWN						
						4

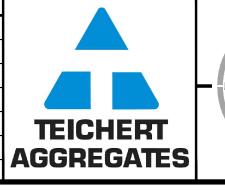



■ Sacramento Office

(916) 455-2026

CECWEST.COM

(530) 758-2026 YOLO COUNTY


Davis, CA 95618


CROSS SECTION D-D

SHIFLER RECLAMATION PLAN

R-06 9

DATE: 02/08/16 CALIFORNIA JOB NO: 1129.20

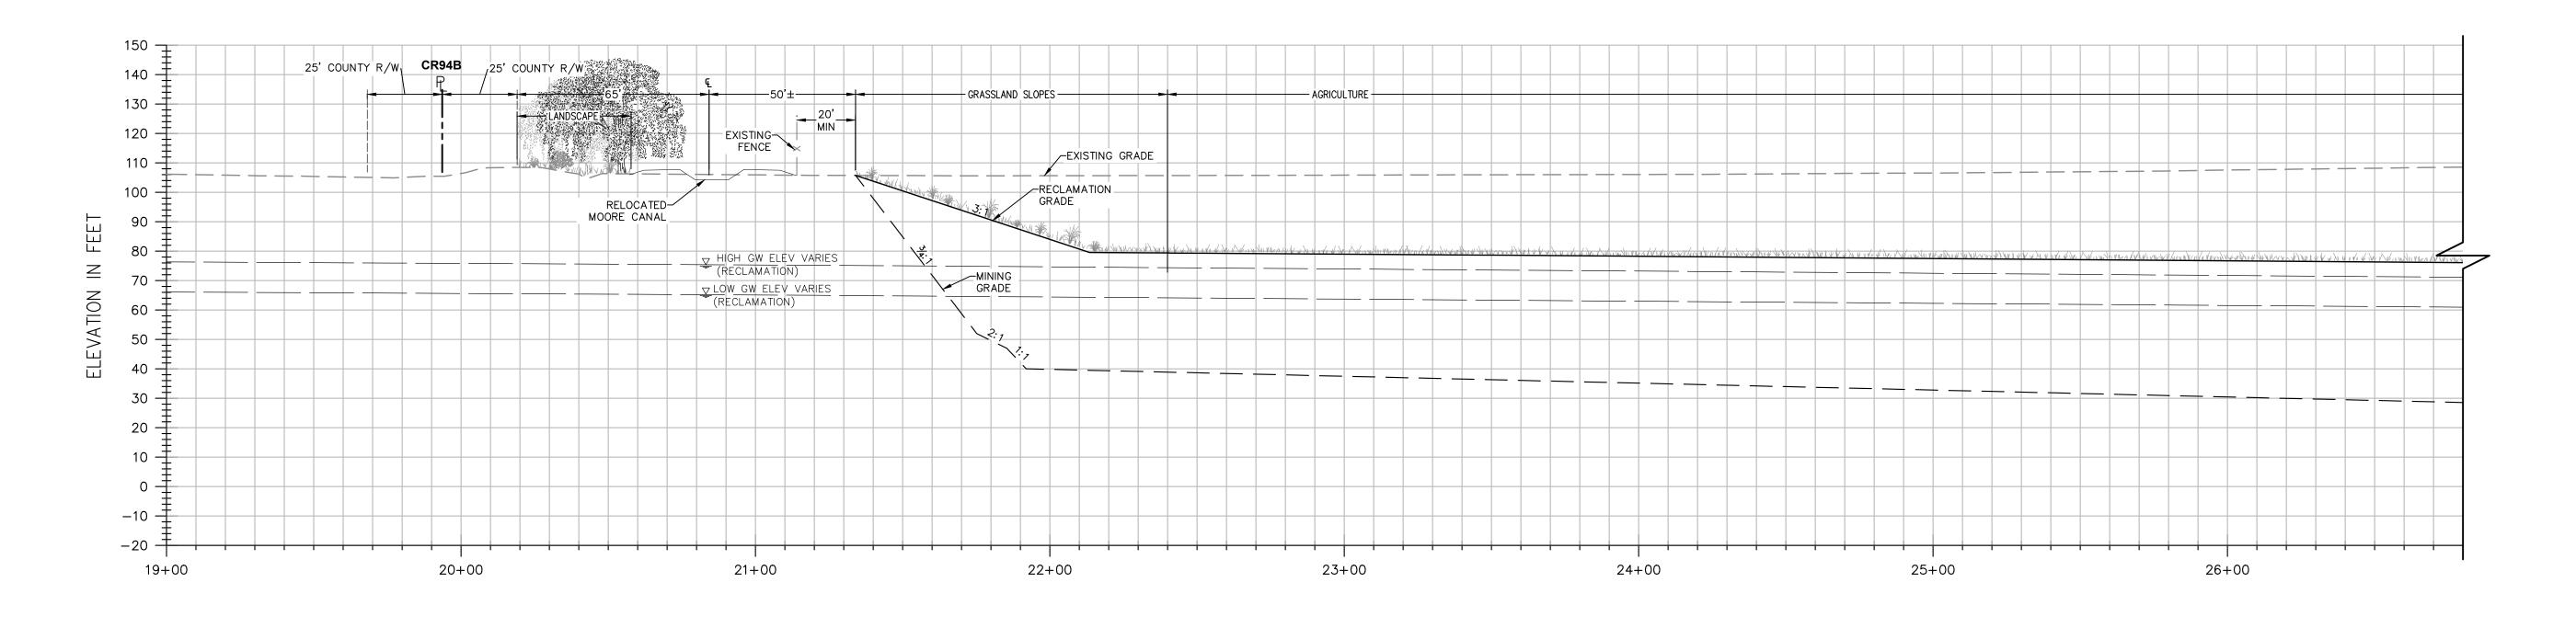

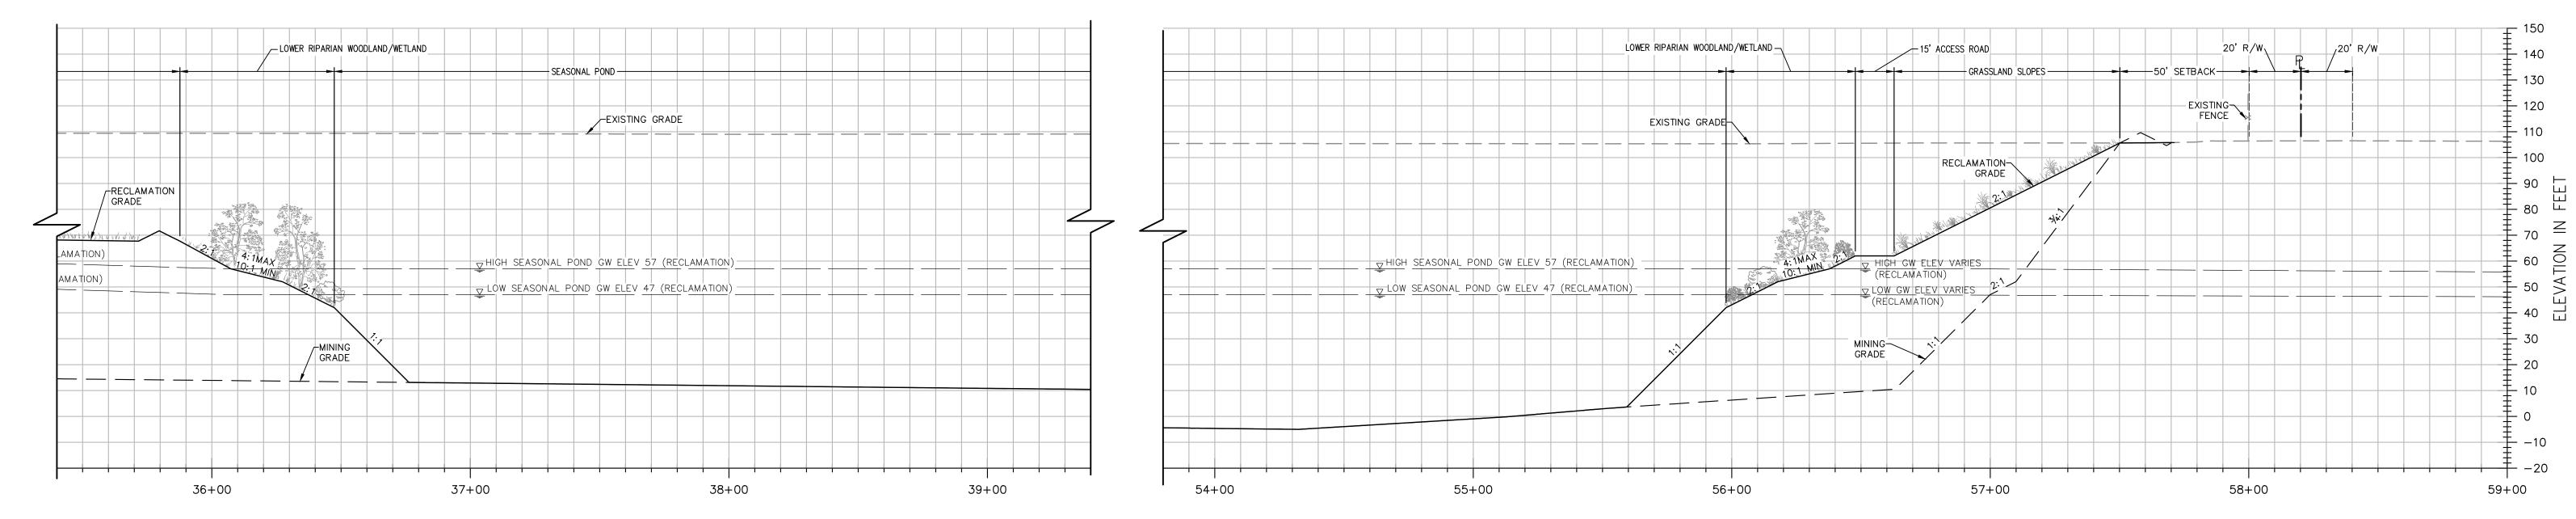

SECTION E-E


NOTES:

- 1. ELEVATIONS AND DISTANCES ARE APPROXIMATE. EXISTING GROUND IS BASED ON AERIAL TOPOGRAPHY FLOWN IN APRIL 2010 BY POINT CO. PHOTOGRAMMETRIC
- 2. HIGH AND LOW AVERAGE GROUNDWATER ELEVATIONS BASED ON "GROUNDWATER CONDITIONS IN THE VICINITY OF PLANNED WETPIT MINING OPERATIONS, SHIFFLER PROPERTY" AND "CONTOURS OF PREDICTED GROUNDWATER ELEVATION, AVERAGE FALL LOW, POST-RECLAMATION",, BY LUHDORFF & SCALMANINI CONSULTING ENGINEERS DATED DECEMBER 22, 2015, UPDATED FEBRUARY 2016.
- 3. BERMS OR V-DITCHES TO BE ADDED ALONG THE TOP OF SLOPES AS NECESSARY TO KEEP SURFACE RUNOFF FROM ADJACENT AREAS FROM ENTERING INTO THE DESIGNATED
- 4. BOTTOM MINING ELEVATIONS ARE $\pm 10^{\circ}$ DEPENDING ON ACTUAL BOTTOM OF GRAVEL
- 5. AGRICULTURE ZONES TO HAVE MINIMUM OF 5' OF TOPSOIL AND SHALL BE A MINIMUM OF 5' ABOVE THE AVERAGE HIGH GROUNDWATER LEVEL.

SCALE 1" = 30'HOR. SCALE 1" = 30'VERT.



DESIGNED BY NC	NO.	DATE	REVISIONS	BY	APPD.	
DRAWN BYNC/LR_						
CHECKED BY SG						
SCALE						
AS SHOWN						
AS SHOWN						
						1

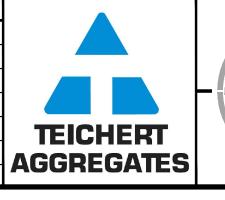



CECWEST.COM

(530) 758-2026

YOLO COUNTY

Project Planning ■ Civil Engineering ■ Landscape Architecture ■ Sacramento Office 120 20th Street, Suite Three 2940 Spafford Street, Suite 200 Sacramento, CA 95818 Davis, CA 95618


(916) 455-2026


SHIFLER RECLAMATION PLAN

CROSS SECTION E-E

R-07 9

DATE: 02/08/16 CALIFORNIA JOB NO: 1129.20

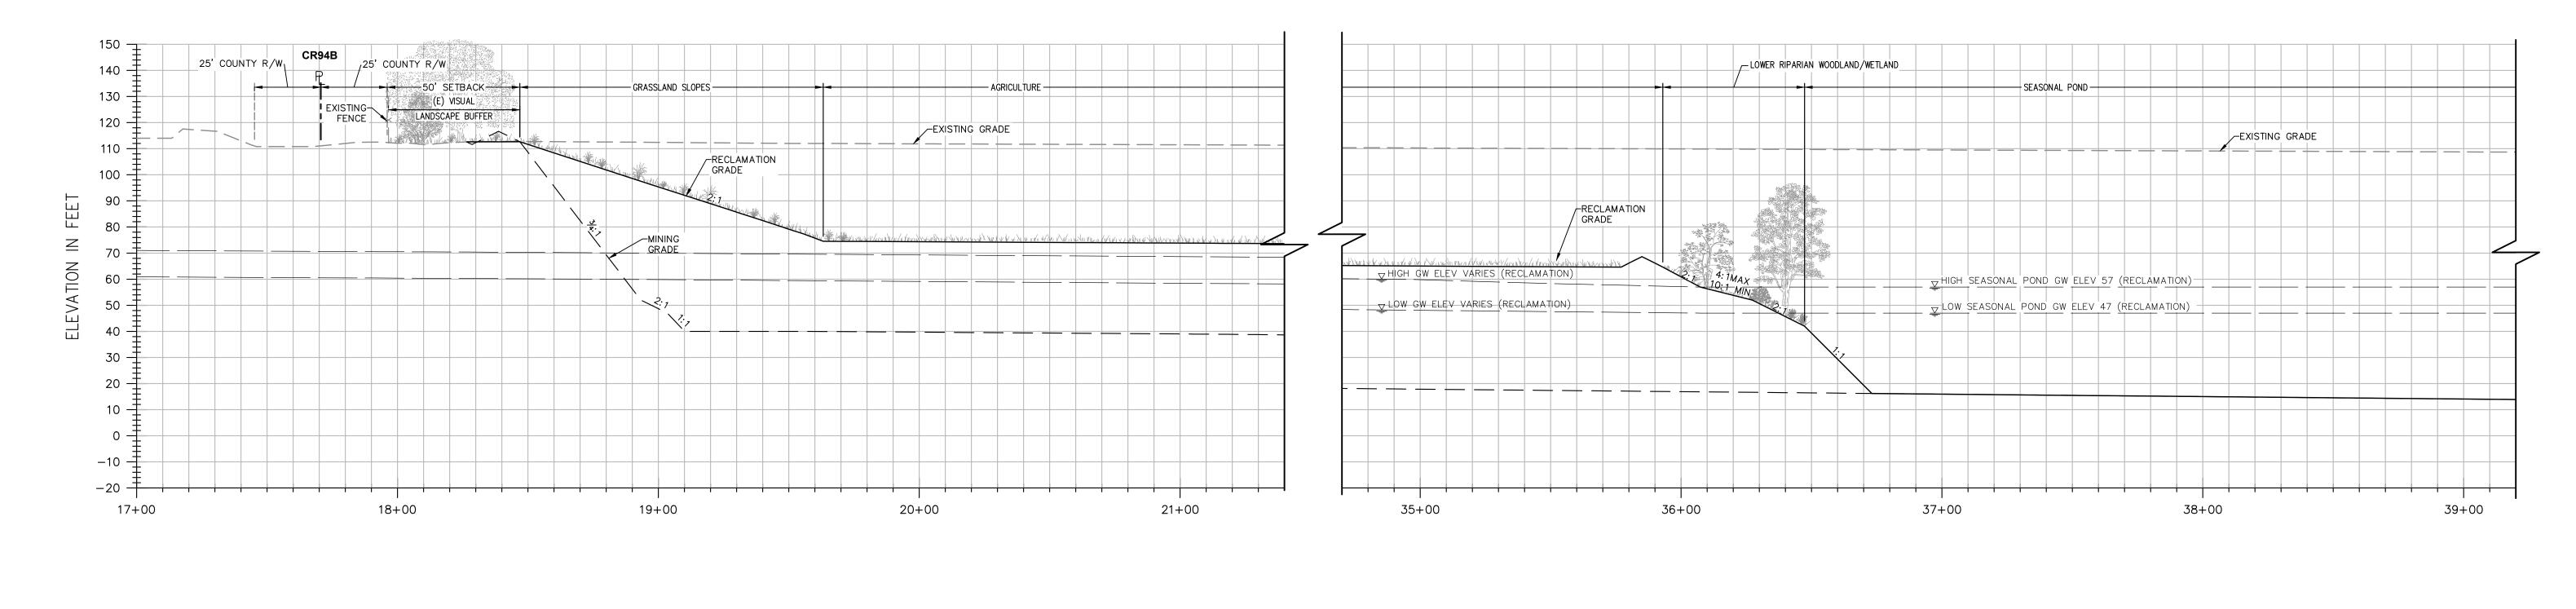

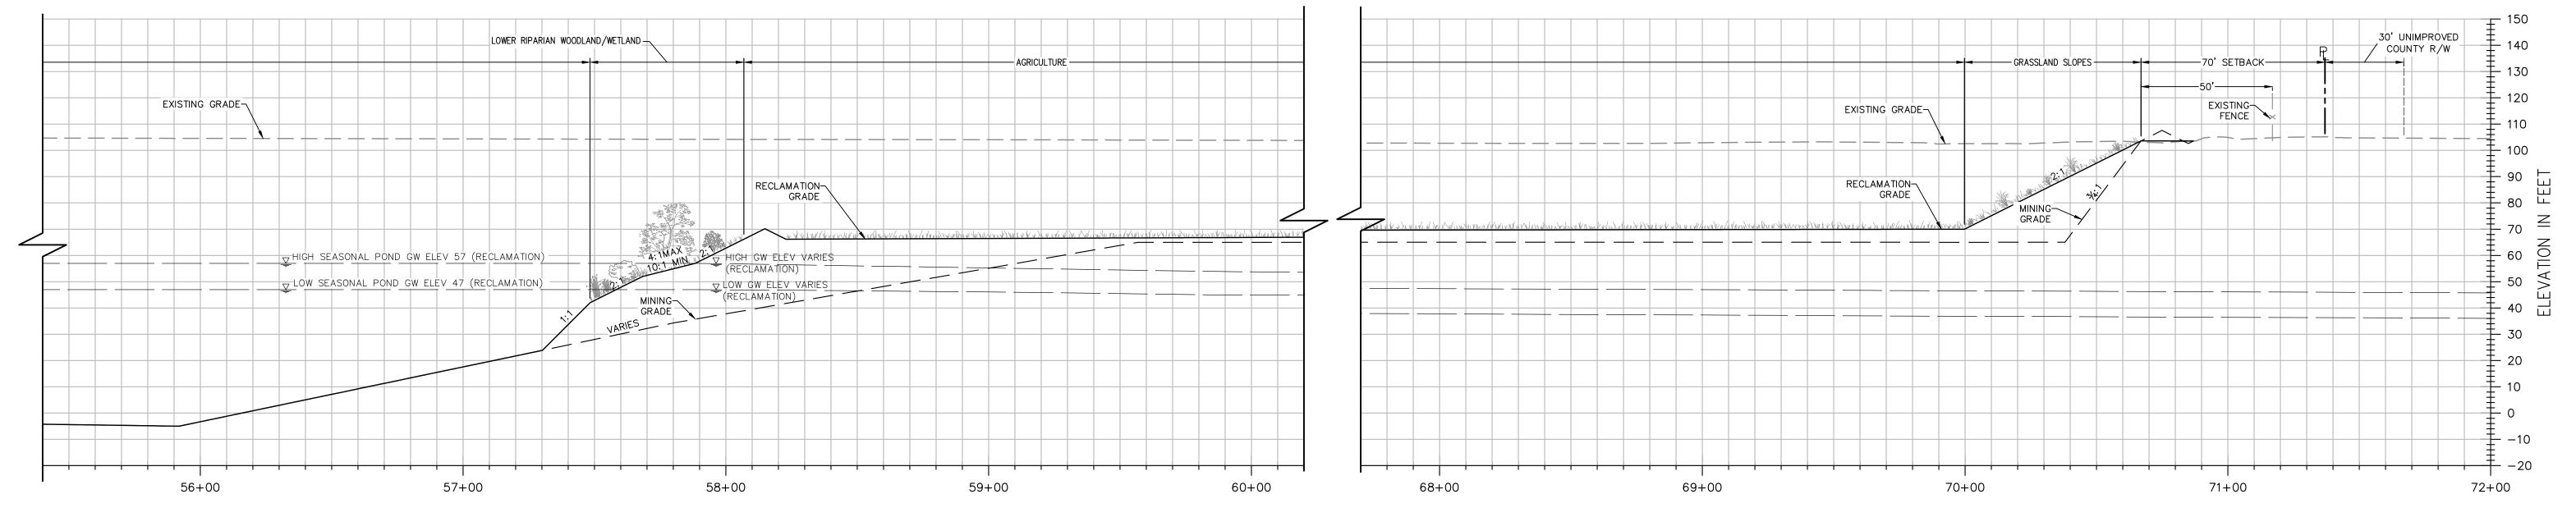

SECTION F-F


NOTES:

- 1. ELEVATIONS AND DISTANCES ARE APPROXIMATE. EXISTING GROUND IS BASED ON AERIAL TOPOGRAPHY FLOWN IN APRIL 2010 BY POINT CO. PHOTOGRAMMETRIC SERVICES.
- 2. HIGH AND LOW AVERAGE GROUNDWATER ELEVATIONS BASED ON "GROUNDWATER CONDITIONS IN THE VICINITY OF PLANNED WETPIT MINING OPERATIONS, SHIFFLER PROPERTY" AND "CONTOURS OF PREDICTED GROUNDWATER ELEVATION, AVERAGE FALL LOW, POST-RECLAMATION", BOTH BY LUHDORFF & SCALMANINI CONSULTING ENGINEERS DATED DECEMBER 22, 2015, UPDATED FEBRUARY 2016.
- 3. BERMS OR V—DITCHES TO BE ADDED ALONG THE TOP OF SLOPES AS NECESSARY TO KEEP SURFACE RUNOFF FROM ADJACENT AREAS FROM ENTERING INTO THE DESIGNATED OPEN WATER
- 4. BOTTOM MINING ELEVATIONS ARE ± 10 ' DEPENDING ON ACTUAL BOTTOM OF GRAVEL DEPTHS.
- 5. AGRICULTURE ZONES TO HAVE MINIMUM OF 5' OF TOPSOIL AND SHALL BE A MINIMUM OF 5' ABOVE THE AVERAGE HIGH GROUNDWATER LEVEL.

SCALE 1" = 30'HOR. SCALE 1" = 30'VERT.



BY APPD. REVISIONS DESIGNED BY NC DRAWN BY NC/LR CHECKED BY SG SCALE AS SHOWN

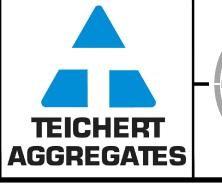



CECWEST.COM


 $\textit{Project Planning} \; \blacksquare \; \textit{Civil Engineering} \; \blacksquare \; \textit{Landscape Architecture}$ ■ Sacramento Office 120 20th Street, Suite Three 2940 Spafford Street, Suite 200 Sacramento, CA 95818 Davis, CA 95618 (530) 758-2026 YOLO COUNTY


(916) 455-2026

SHIFLER RECLAMATION PLAN

CROSS SECTION F-F

R-08 9 DATE: 02/08/16

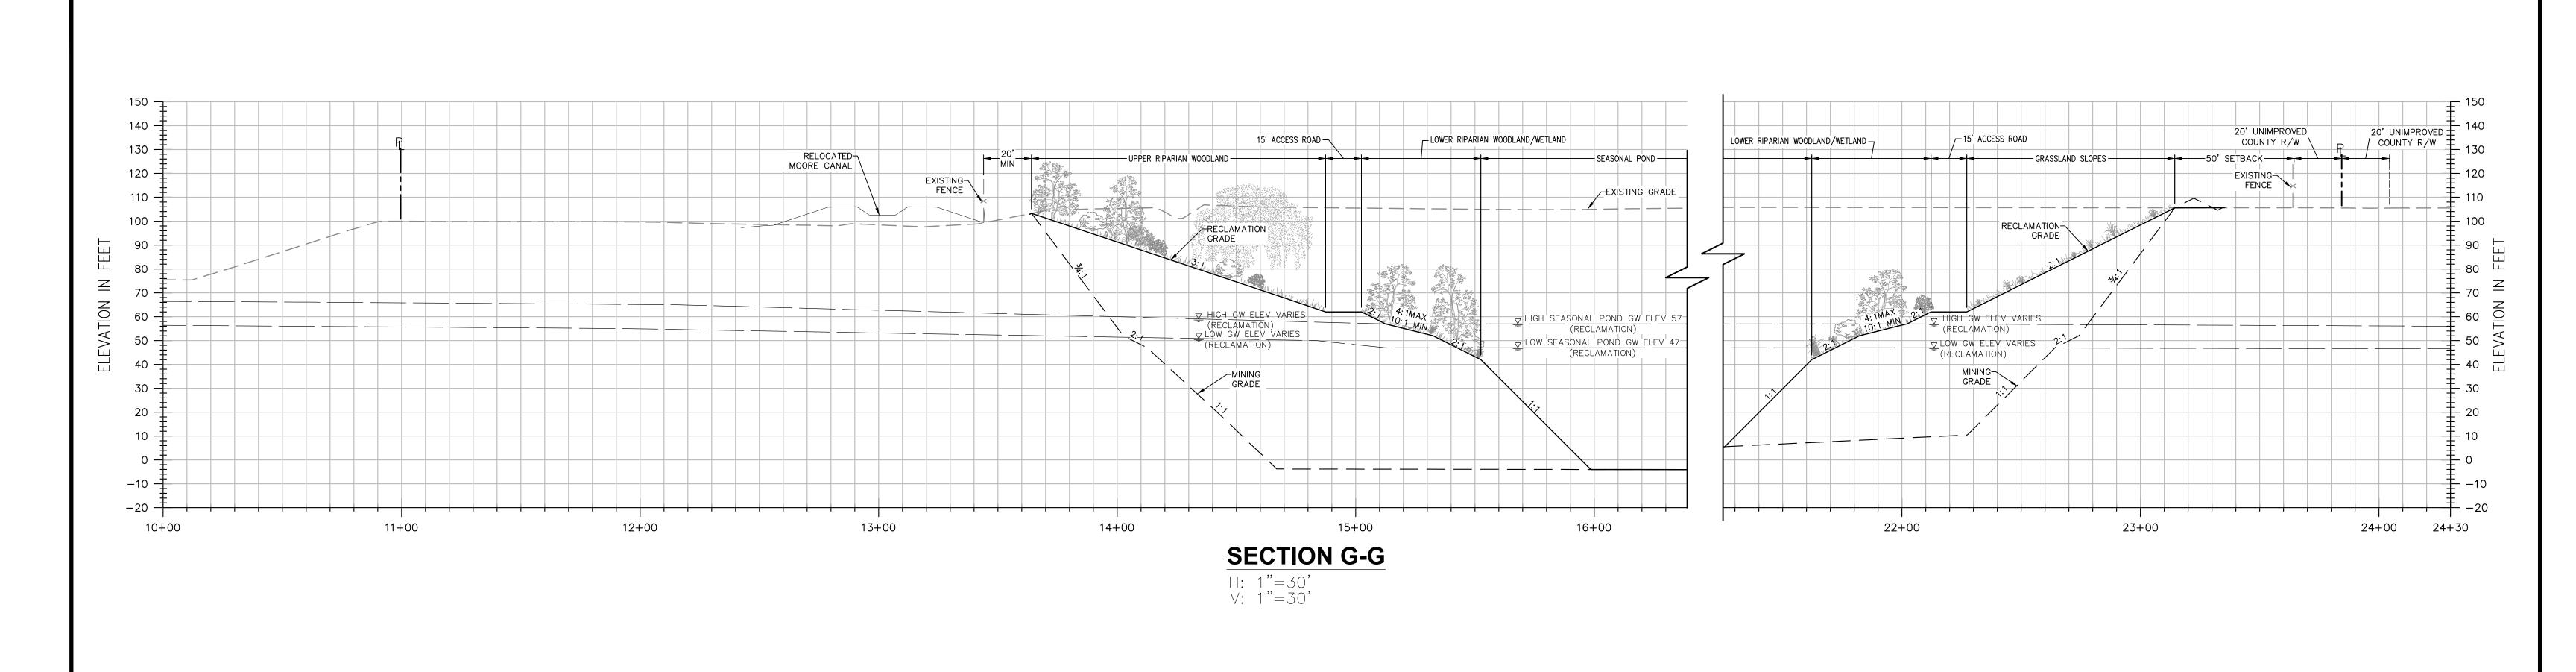

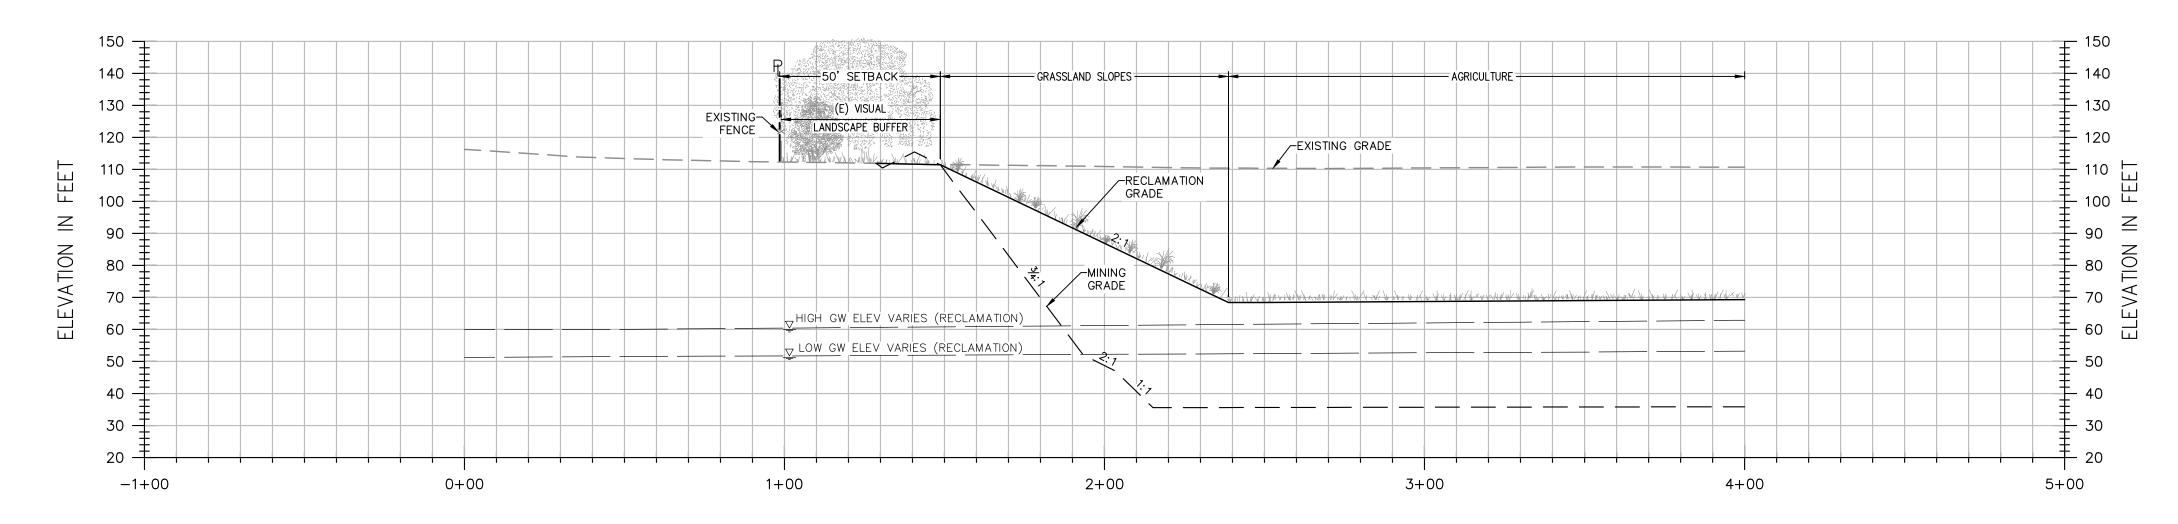

SECTION H-H

NOTES:

- 1. ELEVATIONS AND DISTANCES ARE APPROXIMATE. EXISTING GROUND IS BASED ON AERIAL TOPOGRAPHY FLOWN IN APRIL 2010 BY POINT CO. PHOTOGRAMMETRIC SERVICES.
- 2. HIGH AND LOW AVERAGE GROUNDWATER ELEVATIONS BASED ON "GROUNDWATER CONDITIONS IN THE VICINITY OF PLANNED WETPIT MINING OPERATIONS, SHIFFLER PROPERTY" AND "CONTOURS OF PREDICTED GROUNDWATER ELEVATION, AVERAGE FALL LOW, POST—RECLAMATION", BOTH BY LUHDORFF & SCALMANINI CONSULTING ENGINEERS DATED DECEMBER 22, 2015, UPDATED
- 3. BERMS OR V—DITCHES TO BE ADDED ALONG THE TOP OF SLOPES AS NECESSARY TO KEEP SURFACE RUNOFF FROM ADJACENT AREAS FROM ENTERING INTO THE DESIGNATED OPEN WATER
- 4. BOTTOM MINING ELEVATIONS ARE $\pm 10^{\circ}$ DEPENDING ON ACTUAL BOTTOM OF GRAVEL DEPTHS.
- 5. AGRICULTURE ZONES TO HAVE MINIMUM OF 5' OF TOPSOIL AND SHALL BE A MINIMUM OF 5' ABOVE THE AVERAGE HIGH GROUNDWATER LEVEL.

SCALE 1" = 30'HOR. SCALE 1" = 30'VERT.



DESIGNED BY NC	NO.	DATE	REVISIONS	BY	APPD.	
						ĺ
DRAWN BYNC/LR_						
CHECKED BY SG						
SCALE						
AS SHOWN						
AS SHOWN						1
						•





CECWEST.COM

Project Planning ■ Civil Engineering ■ Landscape Architecture ■ Sacramento Office ■ Davis Offic 120 20th Street, Suite Three 2940 Spafford Street, Suite 200 Sacramento, CA 95818 Davis, CA 95618 (530) 758-2026 YOLO COUNTY

SHIFLER RECLAMATION PLAN

CROSS SECTION G-G & H-H

R-09 9

DATE: 02/08/16