

YOLO COUNTY AIRPORT

AIRPORT DRAINAGE BASIN IMPROVEMENTS WOODLAND, CA AIP NO.: **MARCH 2019**

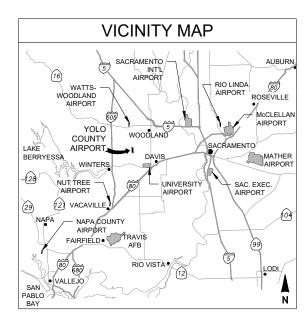

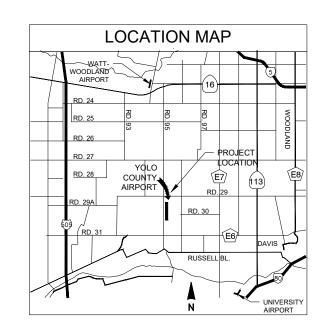



SHEET INDEX

SHEET NUMBER	SHEET TITLE
G-001	COVER SHEET
G-002	LEGEND & ABBREVIATIONS
G-021	PROJECT LAYOUT PLAN
G-041	SURVEY CONTROL
G-081	CONSTRUCTION SAFETY AND PHASING PLANS - PHASE 1
G-082	CONSTRUCTION SAFETY AND PHASING PLANS - PHASE 2
C-021	EROSION CONTROL PLANS
C-031	EROSION CONTROL DETAILS
C-051	DEMOLITION PLANS
C-101	GRADING PLAN
C-301	TYPICAL SECTIONS
C-401	DRAINAGE PLAN & PROFILES
C-402	DRAINAGE PLAN & PROFILES
C-451	DRAINAGE DETAILS
C-901	CROSS SECTIONS
S-021	STRUCTURAL LAYOUT PLAN

PROJECT DESCRIPTION

- CONSTRUCT ONE DETENTION BASIN
- MODIFY EXISTING WATERWAY CHANNELS THAT WILL FEED INTO NEW DETENTION BASIN
- CONSTRUCT NEW CULVERTS UNDER AVIATION AVENUE IN TWO LOCATIONS



Suite 200 Windsor, CA 95492 phone: 707-526-5010



AIRPORT DRAINAGE BASIN WOODLAND

NOT FOR CONSTRUCTION

MARCH 2019

COVER SHEET

G-001

→ → HAUL or TRAFFIC ROUTE

AB	ACCRECATE DAGE	FL	ELOW/LINE	PVC	DOINT OF VEDTICAL CLIDVE
VC VR	AGGREGATE BASE	FPS	FLOW LINE	PVC	POINT OF VERTICAL CURVE
	ASPHALT CONCRETE		FEET PER SECOND		POLYVINYL CHLORIDE
LT	ALTERNATE	FT	FEET	PVI	POINT OF VERTICAL INTERSECTION
OA	AIRCRAFT OPERATIONS AREA	G	GAS LINE	PVT	POINT OF VERTICAL TANGENCY
PCH	APPROACH	GAL	GALLON	Q	RATE OF FLOW
PPROX	APPROXIMATE	GALV	GALVANIZED	QTY	QUANTITY
SB	AGGREGATE SUB-BASE	GB	GRADE BREAK	R	RADIUS
R	ACCESS ROAD	GND	GROUND	R&R	REMOVE AND REPLACE
TCT	AIR TRAFFIC CONTROL TOWER	GPM	GALLONS PER MINUTE	RC	RELATIVE COMPACTION
WG -	AMERICAN WIRE GAUGE	GS	GROUND SHOT	RCP	REINFORCED CONCRETE PIPE
C _	BEGINNING OF CURVE	H	HEIGHT	REQ	REQUIRED
Т	BITUMINOUS	HDPE	HIGH DENSITY POLYETHYLENE	ROW	RIGHT OF WAY
.DG	BUILDING	HIRL	HIGH INTENSITY RUNWAY LIGHT	RWA	RUNWAY WORK RESTRICTED AREA
И	BENCHMARK	HIR;THL	HIGH INTENSITY THRESHOLD LIGHT	RWY	RUNWAY
TOT	ВОТТОМ	HORIZ	HORIZONTAL	S	SANITARY LINE
/C	BEGINNING OF VERTICAL CURVE	HP	HIGH POINT	SF	SQUARE FOOT
-C	CENTER TO CENTER	HW	HEADWALL	SG	STRAIGHT GRADE
В	CATCH BASIN	HWL	HIGH WATER LEVEL	SH	SHOULDER
IPCP	CAST IN-PLACE CONCRETE PIPE	HWY	HIGHWAY	SIDA	SECURITY IDENTIFICATION DISPLAY AREA
J	CONSTRUCTION JOINT	IE	INVERT ELEVATION	SMGS	SURFACE MOVEMENT GUIDANCE AND CONTROL SYSTEM
-s	CUBIC FEET PER SECOND	IN	INCHES	ss	STAINLESS STEEL
-	CENTERLINE	L	LENGTH	ST	STORM LINE
.F	CHAINLINK FENCE	LBS	POUNDS	STA	STATION
_R	CLEAR	LF	LINEAL FEET	STD	STANDARD
MP	CORRUGATED METAL PIPE	LWL	LOW WATER LEVEL	STL	STEEL
)	CLEANOUT	MAX	MAXIMUM	Т	TELEPHONE LINE
ONC	CONCRETE	MID	MID POINT	TC	TOP OF CURB
TNC	CONTINUOUS	MIN	MINIMUM	TG	TOP OF GRATE
RGO	CARGO	MIRL	MEDIUM INTENSITY RUNWAY LIGHT	T/L	TAXILINE
P	CONTROL POINT	MITL	MEDIUM INTENSITY TAXIWAY LIGHT	TOE	TOE OF BANK
ГВ	CEMENT TREATED BASE	MPH	MILES PER HOUR	TOP	TOP OF BANK
3	DIRECT BURIAL	(N)	NEW	TWY	TAXIWAY
EG	DEGREE	NO. OR#	NUMBER	TYP	TYPICAL
	DROP INLET	NOTMA	NOTICE TO AIRMAN	UD	UNDERDRAIN
Α	DIAMETER	NTS	NOT TO SCALE	UG	UNDERGROUND
М	DIMENSION	ос	ON CENTER	UON	UNLESS OTHERWISE NOTED
Р	DUCTILE IRON PIPE	ОН	OVERHEAD	v	VELOCITY
-	DEPTH	ows	OIL WATER SEPERATOR	VC	VERTICAL CURVE
)	EXISTING	РВ	PULL BOX	VERT	VERTICAL
	ELECTRICAL LINE	PC	POINT OF CURVATURE	VG	VALLEY GUTTER
	END OF CURVE	PCC	PORTLAND CEMENT CONCRETE	VIF	VERIFY IN FIELD
G	EXISTING GRADE	PCF	POUNDS PER CUBIC FOOT	w	WATER LINE
.EV	ELEVATION	PERF	PERFORATED	W/	WITH
)P	EDGE OF PAVEMENT	PI	POINT OF INTERSECTION	W/O	WITHOUT
/C	END OF VERTICAL CURVE	РОВ	POINT OF BEGINNING	WSE	WATER SURFACE ELEVATION
A	FEDERAL AVIATION ADMINISTRATION	POC	POINT OF CURVE	WSP	WELDED STEEL PIPE
80	FIXED BASE OPERATOR	POE	POINT OF ENDING	wv	WATER VALVE
:	FINISHED FLOOR	PSI	POUNDS PER SQUARE INCH	wwm	WELDED WIRE MESH
3	FINISHED GRADE	PSF	POUNDS PER SQUARE FOOT		
	FIRE HYDRANT	PT	POINT OF TANGENCY		

ARREVIATIONS

Mead Hunt

1360 19th Hole Drive, Suite 200 Windsor, CA 95492 phone: 707-526-5010 meadhunt.com

ese documents shall not be used for any purpopiect for which it is not intended. Mead & Hunt si indemnfied by the client and held harmless and landed form all claims, damages, liabilities, los d expenses, including attomays fees and costs sing out of such misuse or reuse of the documaddition, unauthorized reproduction of these cuments in part or as a whole is prohibited.

YOLO COUNTY AIRPORT AIRPORT DRAINAGE BASIN IMPROVEMENTS

88

WOODLAND, WOODLAND,

NOT FOR CONSTRUCTION

 M8H NO.:
 2502000-170176.01

 DATE:
 MARCH 2019

 DESIGNED BY:
 XXX

 DRAWN BY:
 XXX

DRAWN BY: XXX


CHECKED BY: XXX

DO NOT SCALE DRAWINGS


LEGEND & ABBREVIATIONS


SHEET NO


G-002

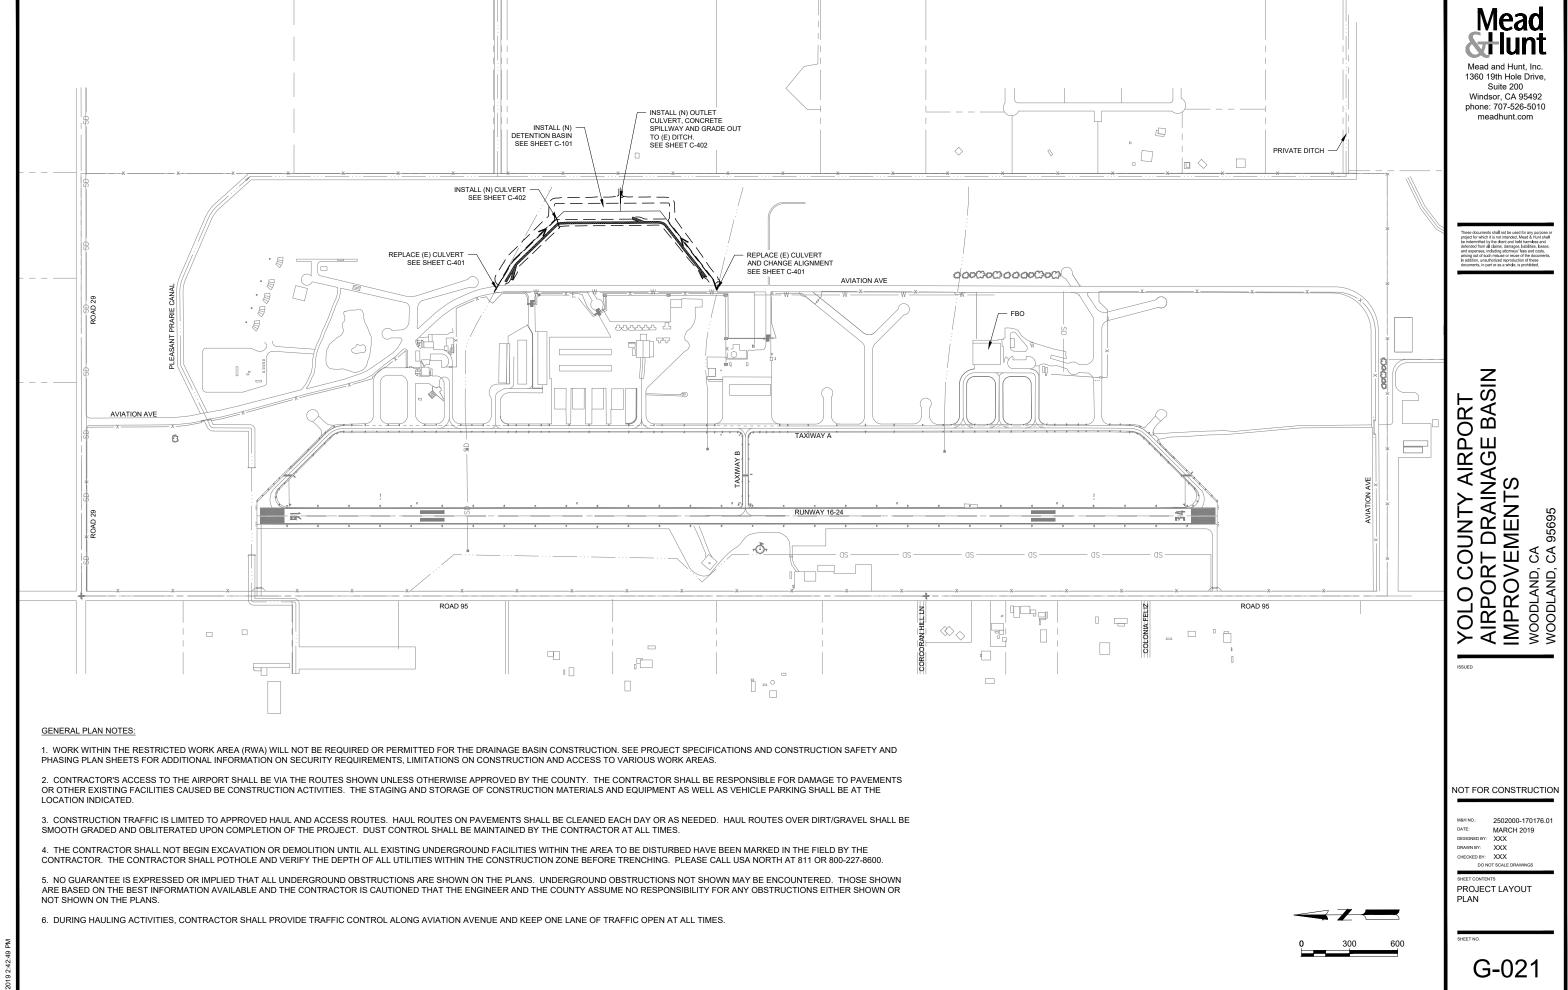


\\CORP.MEADHUNT.COM\SHAREDFOLDERS\ENTP\2502000\\170176.01\TECH\CAD\DRAWINGS\P

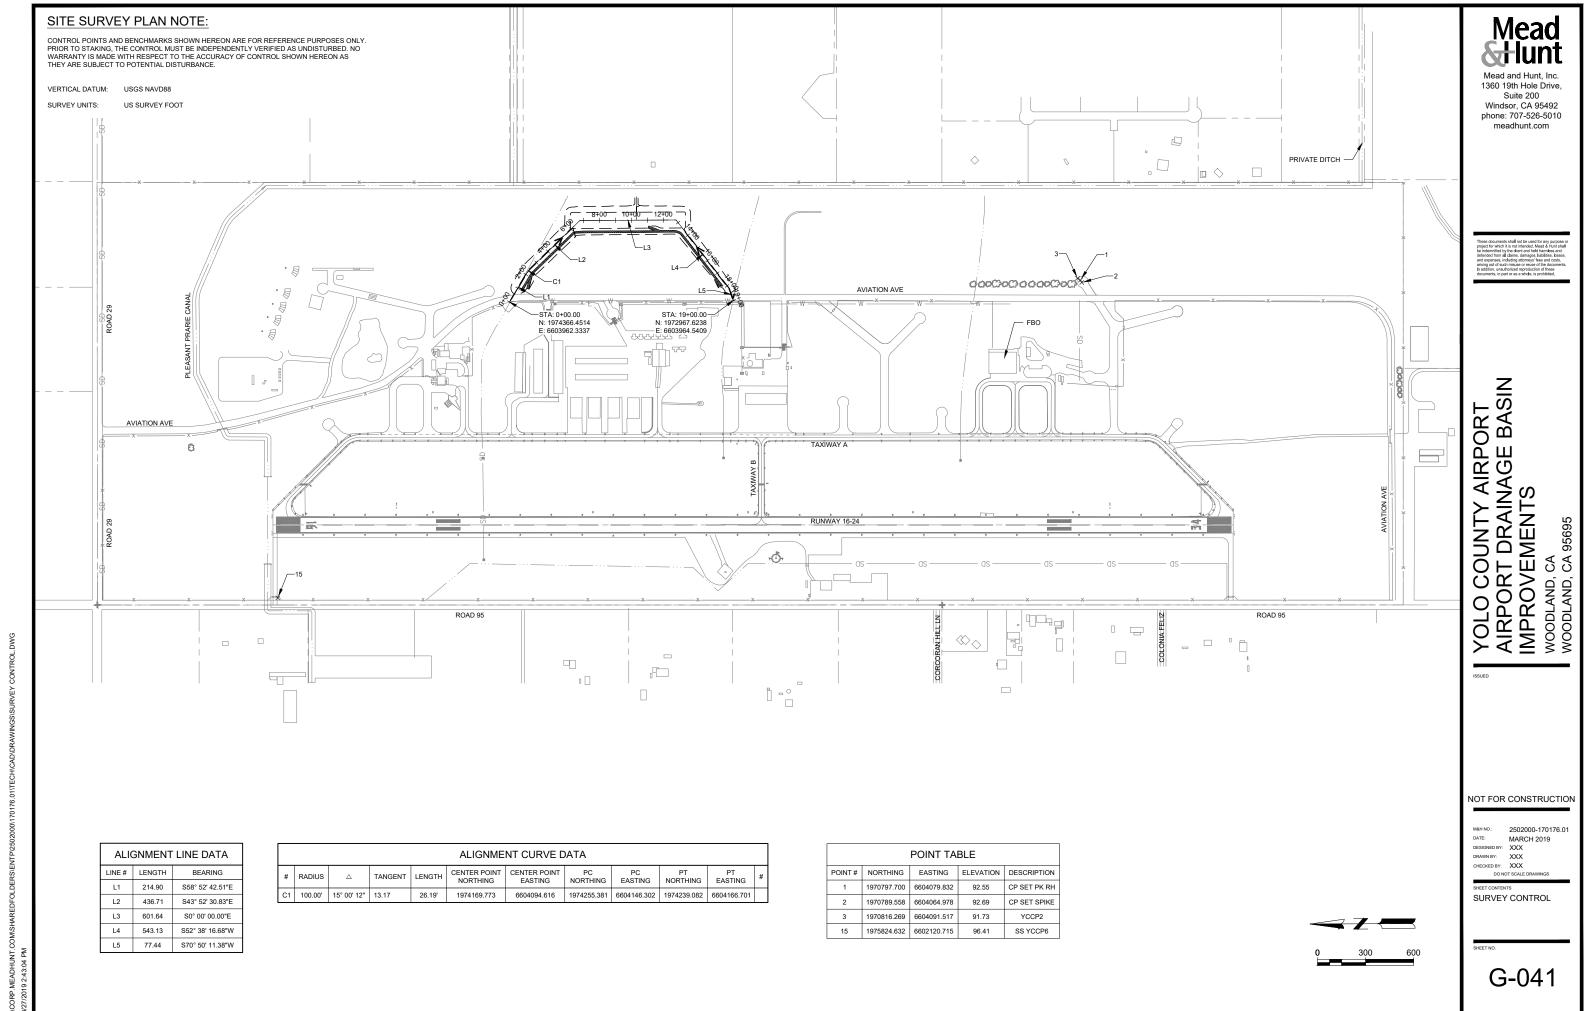


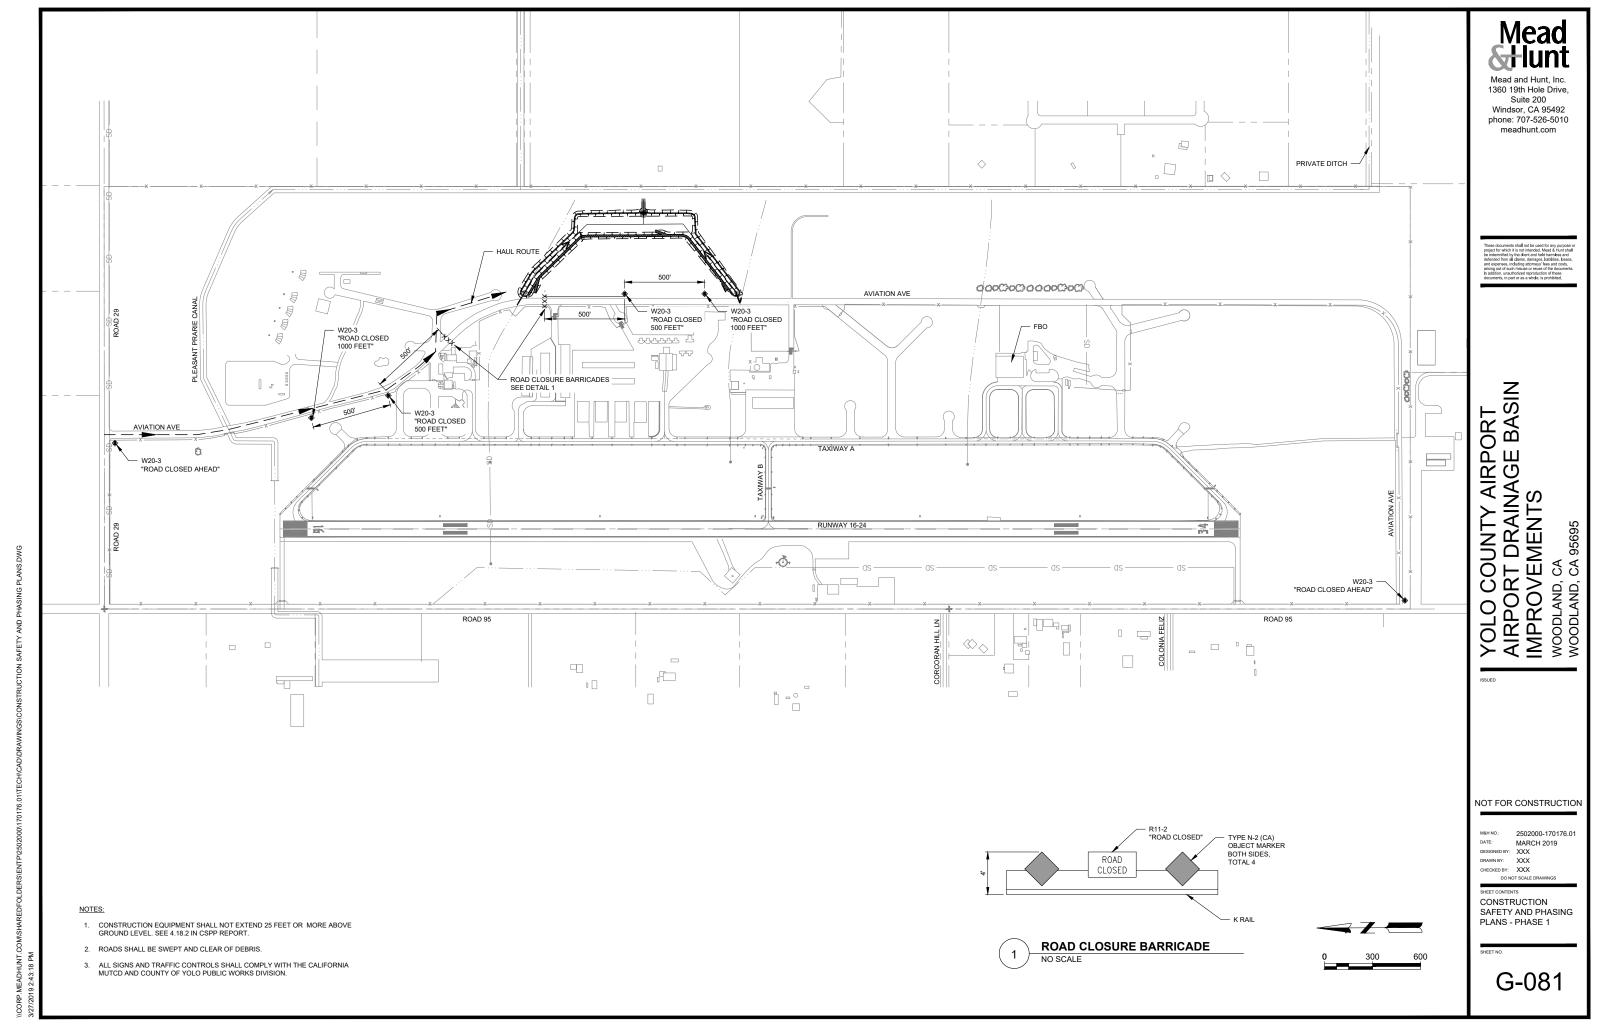

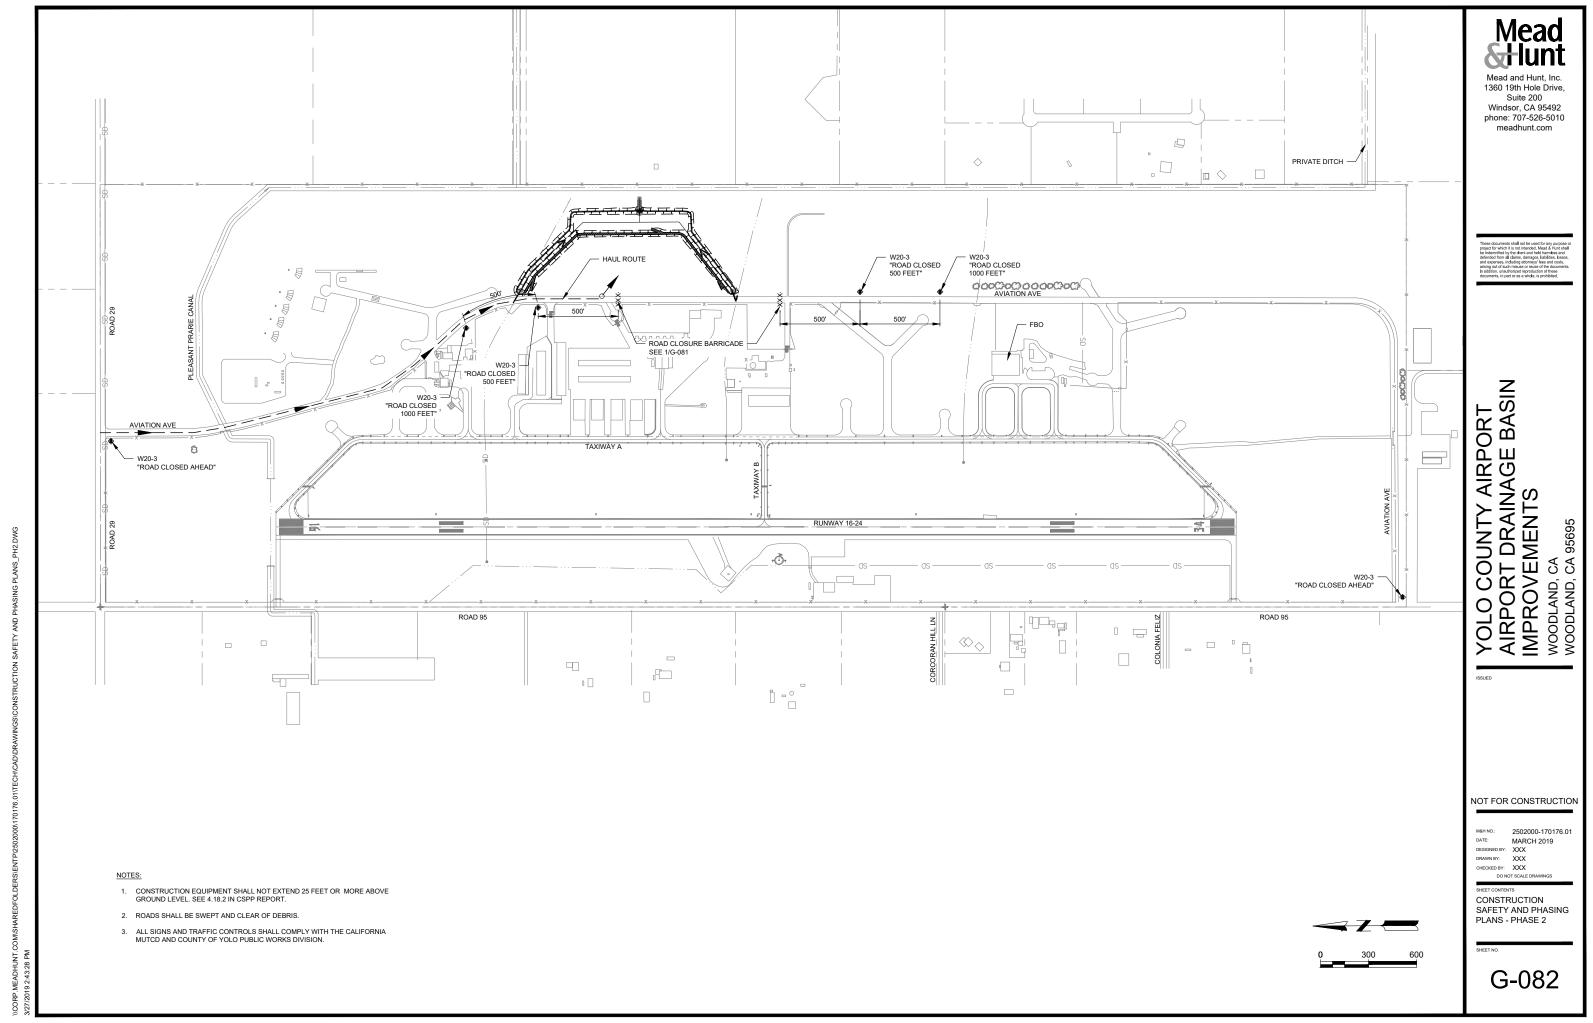

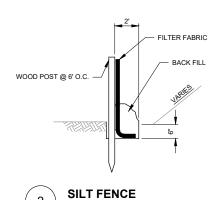


NO SCALE

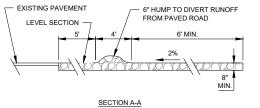


- NOTES:

 1. MAINTAIN THE GRAVEL PAD IN A CONDITION TO PREVENT SEDIMENT FROM LEAVING THE SITE. SHOULD MUD BE TRACKED OR WASHED ONTO EXISTING PAVEMENT, IT MUST BE REMOVED IMMEDIATELY BY VACUUM SWEEPER.
- 2. UPON COMPLETION REMOVE TRACKING PAD AND RESTORE TO ORIGINAL CONDITION.

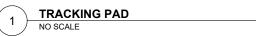

EXISTING PAVEMENT

3" WASHED STONE PLAN

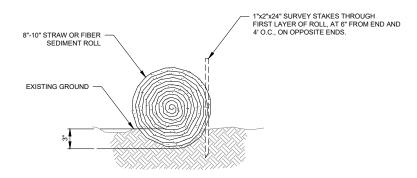






Mead and Hunt, Inc. 1360 19th Hole Drive, Suite 200 Windsor, CA 95492 phone: 707-526-5010 meadhunt.com


YOLO COUNTY AIRPORT AIRPORT DRAINAGE BASIN IMPROVEMENTS WOODLAND, CA WOODLAND, CA 95695

NOT FOR CONSTRUCTION


MAH NO.: 2502000-170176
DATE: MARCH 2019
DESIGNED BY: XXX
DRAWN BY: XXX
CHECKED BY: XXX
DO NOT SCALE DRAWINGS 2502000-170176.01

EROSION CONTROL DETAILS

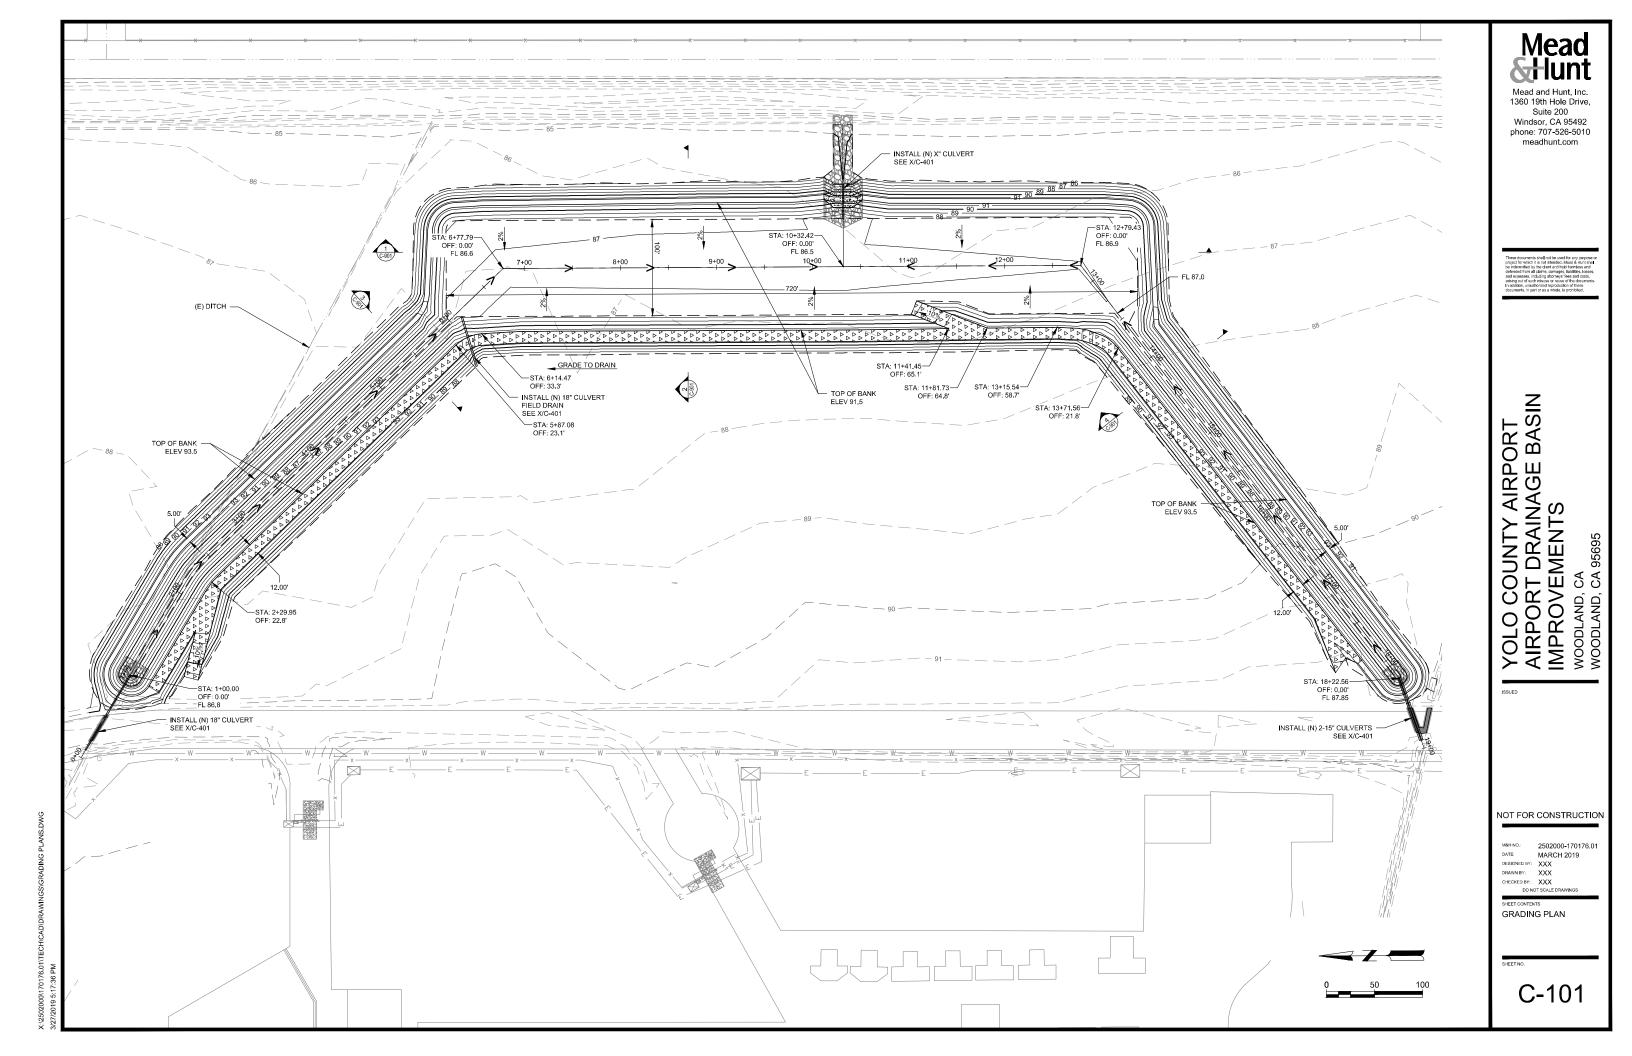

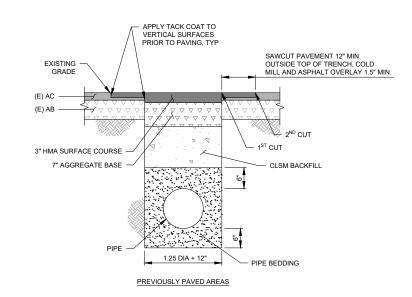

PIPE TRENCHING Χ NO SCALE

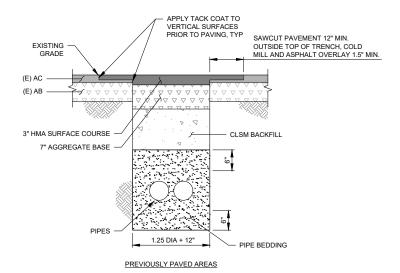

PIPE TRENCHING NO SCALE

Mead

Mead and Hunt, Inc. 1360 19th Hole Drive, Suite 200 Windsor, CA 95492 phone: 707-526-5010 meadhunt.com

YOLO COUNTY AIRPORT AIRPORT DRAINAGE BASIN IMPROVEMENTS WOODLAND, CA WOODLAND, CA 95695


NOT FOR CONSTRUCTION

M&H NO.: DATE: 2502000-170176.01 DATE: MARCH 2019
DESIGNED BY: XXX
DRAWN BY: XXX

CHECKED BY: XXX

DO NOT SCALE DRAWINGS

TYPICAL SECTIONS

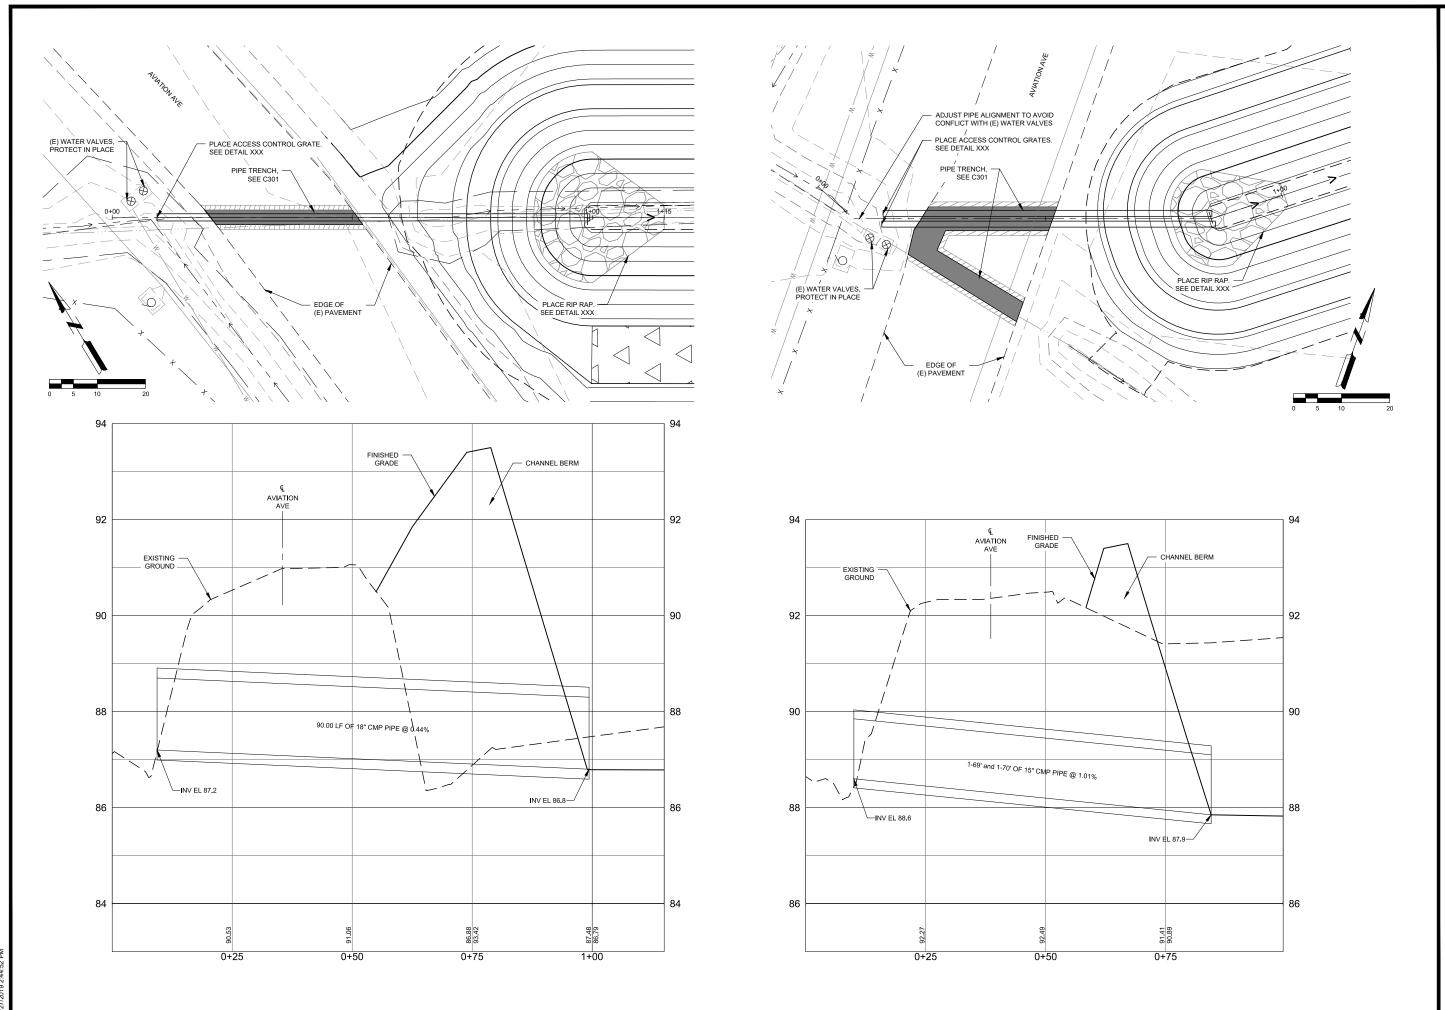

Mead


Mead and Hunt, Inc. 1360 19th Hole Drive, Suite 200 Windsor, CA 95492 phone: 707-526-5010 meadhunt.com

YOLO COUNTY AIRPORT AIRPORT DRAINAGE BASIN IMPROVEMENTS WOODLAND, CA WOODLAND, CA 95695

NOT FOR CONSTRUCTION

MAH NO.: 2502000-170176
DATE: MARCH 2019
DESIGNED BY: XXX
DRAWN BY: XXX
CHECKED BY: XXX
DO NOT SCALE DRAWINGS 2502000-170176.01

DRAINAGE PLAN & PROFILES

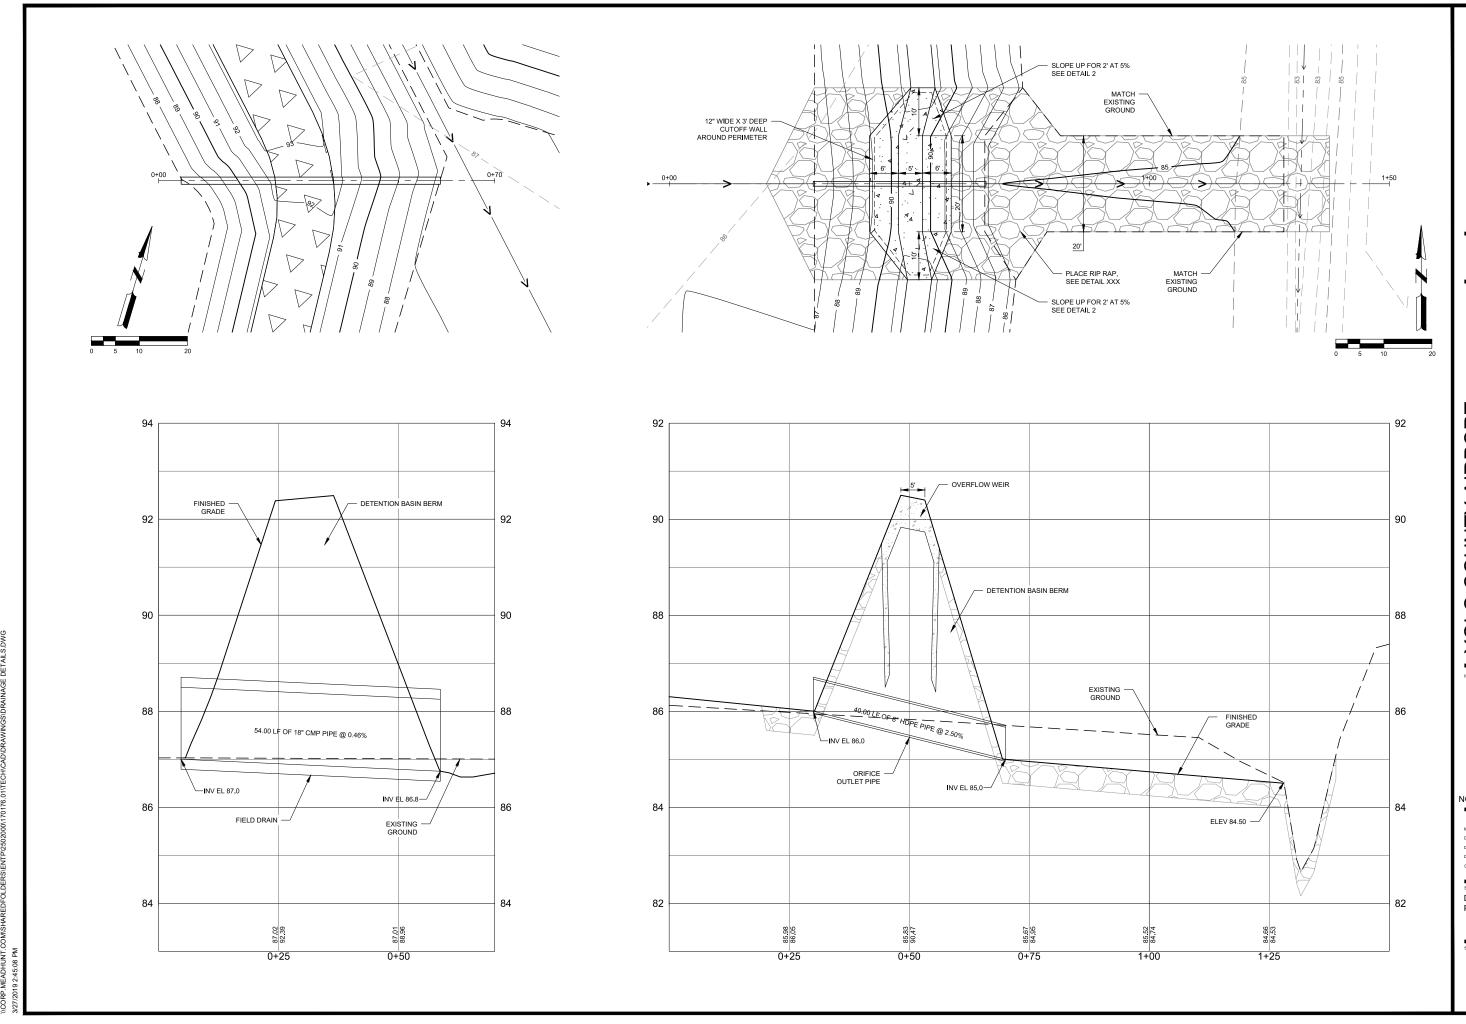

Mead Unt

Mead and Hunt, Inc. 1360 19th Hole Drive, Suite 200 Windsor, CA 95492 phone: 707-526-5010 meadhunt.com

YOLO COUNTY AIRPORT AIRPORT DRAINAGE BASIN IMPROVEMENTS WOODLAND, CA WOODLAND, CA 95695

NOT FOR CONSTRUCTION

MAH NO.: 2502000-170176
DATE: MARCH 2019
DESIGNED BY: XXX
DRAWN BY: XXX
CHECKED BY: XXX
DO NOT SCALE DRAWINGS 2502000-170176.01

DRAINAGE PLAN & PROFILES

Mead Unt


Mead and Hunt, Inc. 1360 19th Hole Drive, Suite 200 Windsor, CA 95492 phone: 707-526-5010 meadhunt.com

YOLO COUNTY AIRPORT AIRPORT DRAINAGE BASIN IMPROVEMENTS WOODLAND, CA WOODLAND, CA 95695


NOT FOR CONSTRUCTION

MAH NO.: 2502000-170176
DATE: MARCH 2019
DESIGNED BY: XXX
DRAWN BY: XXX
CHECKED BY: XXX
DO NOT SCALE DRAWINGS 2502000-170176.01

DRAINAGE DETAILS

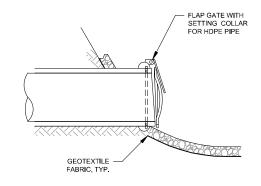



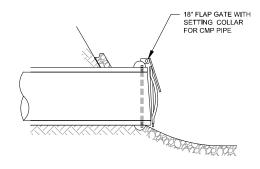

FIELD DRAIN CULVERT FLAP GATE

Mead Munt

Mead and Hunt, Inc. 1360 19th Hole Drive, Suite 200 Windsor, CA 95492 phone: 707-526-5010 meadhunt.com


YOLO COUNTY AIRPORT AIRPORT DRAINAGE BASIN IMPROVEMENTS WOODLAND, CA WOODLAND, CA 95695

ISSUED


NOT FOR CONSTRUCTION

MAIN NO. 2502000-170176.01
DATE: MARCH 2019
DESIGNED BY: XXX
DRAWN BY: XXX
CHECKED BY: XXX
DO NOT SCALE DRAWINGS


DRAINAGE DETAILS

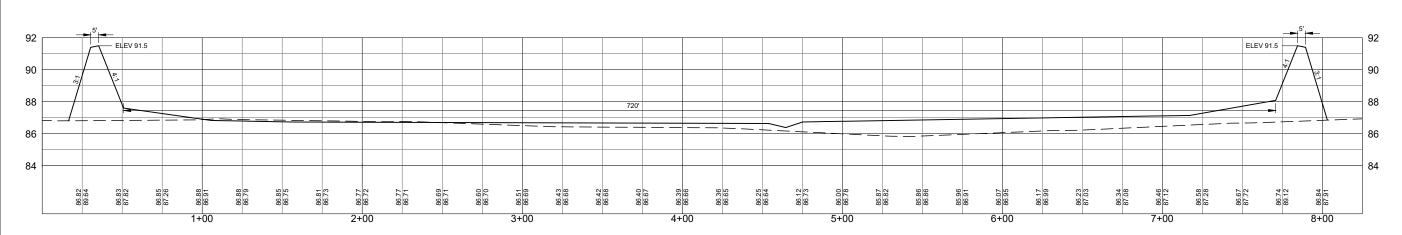


NORTH-SOUTH BASIN SECTION

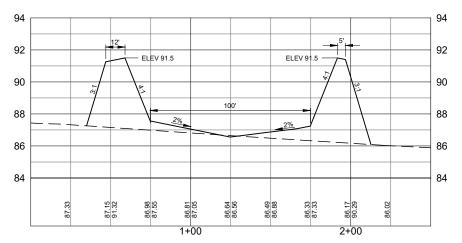

EAST-WEST BASIN SECTION

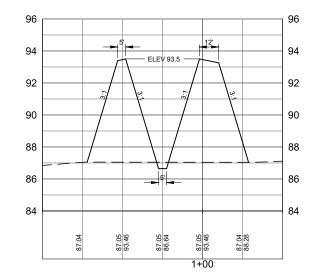



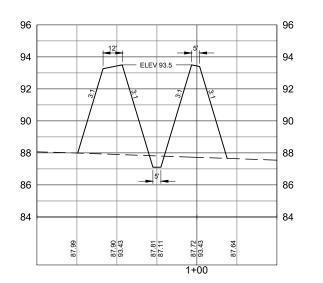

SOUTHERN CANAL 4 SOUTHERN CANA
H SCALE: 1"= 30' V SCALE: 1"= 3'

Mead

Mead and Hunt, Inc. 1360 19th Hole Drive, Suite 200 Windsor, CA 95492 phone: 707-526-5010 meadhunt.com

YOLO COUNTY AIRPORT AIRPORT DRAINAGE BASIN IMPROVEMENTS WOODLAND, CA WOODLAND, CA 95695

NOT FOR CONSTRUCTION

M&H NO.: DATE: 2502000-170176.01 DATE: MARCH 2019
DESIGNED BY: XXX

DRAWN BY: XXX CHECKED BY: XXX

CROSS SECTIONS

